

Maritime Village: Concept Lighting Planning Report



COMHLACHT CHALAFORT
ÁTHA CLIATH
DUBLIN PORT COMPANY

CUNDALL

Third & Final
Masterplan
Project

Project title	3FM Project	Job number
Report title	Maritime Village - Concept Lighting - Planning Report	1036912

Document revision history

Revision ref	Issue date	Purpose of issue / description of revision
PL01	01 July 2024	Planning Issue

Document validation (latest issue)

05/07/2024

05/07/2024

05/07/2024

 David Deane

Principal author

 Darren Kelly

Checked by

 William Dolan

Verified by

Signed by: Darren Kelly

Signed by: Darren Kelly

Signed by: Darren Kelly

1.0 Contents

1.0	Contents	2
2.0	Project Overview	3
2.1	Introduction	3
2.2	Maritime Village Overview	3
2.3	Appendices	4
3.0	Maritime Village	5
3.1	Maritime Village Buildings and areas	5
3.2	Lighting Standards and Guidelines	5
3.3	Lighting Design Criteria	5
3.4	General Lighting Design Values	6
3.5	Environmental Issues	6
3.6	Proposed Lighting Installation	7
3.7	Proposed Luminaire Types	13
4.0	Appendix 1 – Drawing Register: Maritime Village Concept Lighting	19
5.0	Appendix 2 – Planning Drawings: Maritime Village Concept Lighting	20

2.0 Project Overview

2.1 Introduction

This Concept Lighting planning report has been prepared in support of an application for the 3FM Project being submitted by Dublin Port Company Ltd., focusing in particular on the proposed new Maritime Village site which forms one part of the overall development. The 3FM Project represents the concluding phase of the Masterplan initiatives essential for realizing Dublin Port's full potential by 2040. The project primarily centres on the Dublin Port Company owned lands situated on the Poolbeg Peninsula, which constitutes one-fifth of the entire Dublin Port estate and is commonly referred to as the southern port area.

The proposed development site for the new Maritime Village is located on the western end of the Poolbeg Peninsula in Dublin 4. It is bounded by the East Link Road and Pigeon House Road to the south, the existing Dublin Port container terminal to the east, the Liffey channel to the north, and the existing Poolbeg marina to the west. The new site will cover approximately 1.8 hectares and will combine two areas: the current boat club site, home to Stella Maris Rowing Club, Poolbeg Yacht & Boat Club, and the Ringsend Registered Fishermen & Private Boat Owner's Association facilities, and part of the adjacent MTL container terminal.

The proposed Maritime Village will offer a new city destination for boating and rowing activities, building upon the established uses fostered by local clubs, which are an integral part of the Ringsend community.

The development includes several key enabling actions. These actions involve demolishing the two existing clubhouses and all other associated structures on the club site, relocating existing boat storage areas, decommissioning the existing marina, and forming the new 1.8-hectare site by incorporating part of the adjacent container terminal site. Part of the existing club site will be surrendered for the construction of the new Southern Port Access Route (S.P.A.R) and the adjacent Active Travel Route, and new quay walls will be constructed on the western extent of the site.

The new site will feature three dedicated two-storey club buildings for the Poolbeg Yacht & Boat Club, Stella Maris Rowing Club, and a new Maritime Training Centre, with a combined area of approximately 2,364 SqM. Additionally, it will include a 1.5-storey boat maintenance facility with integrated amenities for the Ringsend Registered Fishermen & Private Boat Owner's Association and Liffey & Port Marine Services, totalling 1,069 SqM. A five-storey Dublin Port Company Ltd. Harbour Operations building with 1,670 SqM of floorspace, including a fourth-floor function room, will also be part of the site.

The waterside amenities will comprise a new 258-berth marina, a dedicated boat launch area for the rowing club, a new slipway and boat lifting facilities, dedicated pontoons for Dublin Port Company Ltd. Harbour Operations, a new fuel berth, and all associated gangway and pontoon access infrastructure.

The project also includes 87 car parking spaces, 148 bicycle parking spaces, dedicated waste storage facilities, a new secure boat storage yard covering 3,965 SqM, two new vehicular entrances, and a new pedestrian crossing for improved site access. Additionally, there will be new publicly accessible landscaped open spaces, new boundary treatments and ISPS fencing where necessary, and associated landscaping, lighting, and site services works.

Overall, this project aims to build on the longstanding traditions established by local clubs and provide enhanced modern facilities for maritime activities, creating a welcoming hub for the club members, the local community and visitors alike.

2.2 Maritime Village Overview

Section 3.0 and beyond of this Report provides details of the lighting design proposed as part of the Maritime Village element of the 3FM Project, consisting of illumination of village precincts, boatyards, carparks and slipway located on the south bank of the river Liffey in Ringsend.

Section 3.1 provides details of the concept lighting design for the exterior of various buildings and other outdoor areas in the maritime village, including clubs, public spaces, car parks, and a boat yard. It does not cover internal building spaces.

Section 3.2 provides details on several lighting standards and guidelines that have been applied, including IS EN 12464-2:2014, IS EN 12665:2018, BS 5489-1: 2013, and various CIBSE SLL codes and handbooks.

Section 3.3 showcases how the lighting is designed to ensure safe movement of people and boats. Different illumination requirements are set for the quay/water's edge and the roads and car parks.

Section 3.4 conveys the different lighting design criteria that are proposed for different locations such as the edge of quays, car parks, boat yard, and roads.

Section 3.5 considers environmental issues of the design like light pollution, damage due to the impact of a maritime environment on the installation, disturbance to wildlife, and energy usage.

Section 3.6 provides details on the proposed lighting installations which include recessed continuous LED linear luminaires, uplighting the beams from first floor level, and LED flood lights mounted on poles of varying heights. Special features like the Feature Crane structure and the Seafarer's Memorial will be illuminated uniquely. The Sunken Area and the Slipway will also have specific lighting arrangements.

Section 3.7 provides details of the proposed luminaire fittings that are proposed to be installed.

2.3 Appendices

This section includes the appendices, which provide additional information and data that support the main content of the document.

Section 4.0: This section showcases the comprehensive drawing register for the 3FM Maritime project, providing a detailed list of all the drawings that have been created and used throughout the project.

Section 5.0: This section displays the planning drawings for the 3FM Maritime project, which have been developed to guide the project's execution and to ensure all aspects of the project are well-planned and organized as well as offering a visual representation of the project's design and layout.

3.0 Maritime Village

3.1 Maritime Village Buildings and areas

The maritime village consists of several buildings and areas as follows:

- Stella Maris Club Building
- Poolbeg Club Building
- Nautical Trust Building
- Harbour Operations Building
- Shared Boat Maintenance & Worksop Facilities
- Seafarer's Memorial
- Public Spaces
- Public Event Spaces
- Car Parking
- Feature Crane
- Sunken Area
- Slipway
- Boat Yard

This section of the report only refers to the external spaces and not to the internal building spaces.

3.2 Lighting Standards and Guidelines

The lighting standards and guidelines that were applied are set out below:

- IS EN 12464-2:2014 Lighting of Workplaces: Outdoor Workplaces
- IS EN 12665:2018 Light and Lighting – Basic Terms and Criteria for Specifying Lighting Requirements
- BS 5489-1: 2013 – Code of Practice for the Design of Road Lighting Part 1: Lighting of Roads and Public Amenity Areas
- CIBSE SLL Code of Lighting 2012
- CIBSE SLL Lighting Handbook 2018
- CIBSE SLL Lighting Guide 6 – Exterior Lighting
- HSA Regulations for Electricity
- IS 10101 National Wiring Regulations

3.3 Lighting Design Criteria

The purpose of the lighting is to provide illumination for the safe movement of people, for recreation and launching boats.

The requirements for illumination along the quay/water's edge is different to that for the roads and car parks.

It is assumed that the traffic in the car parks and roads would be slow moving and would be termed medium traffic level in accordance with IS EN 12464-2.

The illumination of the quay/water's edge would be provided off the adjacent buildings to be less intrusive.

The harbour operations building, it is intended to provide illumination from the underside of overhangs, using the buildings unique form.

The quay side crane structure is an iconic Dublin Dockland piece of industrial archaeology and would be provided with a lighting installation to make it a feature of the site.

3.4 General Lighting Design Values

As each location will have different requirements, the criteria for each will be different.

Set out below are the proposed lighting design criteria for the different locations.

Edge of Quays

- 30 Lux as per Dublin Port Company requirements

Car Parks

- 10 Lux
- 0.25 Uniformity
- Glare 50
- CRI 20

Boat Yard

- 50 Lux
- 0.40 Uniformity
- Glare 50
- CRI 20

Roads

- 10 Lux
- 0.40 Uniformity
- Glare 50
- CRI 20

3.5 Environmental Issues

The following issues relating to environmental issues have been considered during the design:

- Light pollution
- Damage to the installation due to a maritime environment
- Disturbance to the wildlife
- Energy usage

The issue of light pollution has been addressed by applying illumination levels that are not excessive and provide a reasonable Lumen/Watt. The light distribution of the luminaires will be carefully chosen to reduce ULR to a minimum and to limit the spread illumination out of the confines of the project area.

The colour temperature of the LED sources will not be greater than 3000⁰ K to reduce the effect of glare and to provide a reasonable colour rendering.

The proposed design will consider the effect of a maritime atmosphere.

The fall off in lighting levels in the areas adjacent will assist in reducing the impact of the lighting installation on wildlife such as bats and foul.

3.6 Proposed Lighting Installation

The proposed lighting installations at the quay side/ water's edge will be provided by recessed continuous LED linear luminaires recessed into the underside of the first-floor concrete slab and the underside of the roof soffit for the Stella Maris Club Building, Poolbeg Club Building and the Nautical Trust Building. These buildings will also be illuminated on the outside by uplighting the beams from first floor level.

The Shared Boat Maintenance & Workshop Facilities building will be illuminated on the outside by uplighting the beams from the height of the upper glazed section using LED up lights luminaires.

The Port Operation Building unique shape will be picked out by installing linear LED luminaires under the building overhangs that are a feature of the building at different floor levels.

The Feature Crane structure will be illuminated by recessed linear LEDs into the structure to make the shape stand out similar to the historic crane in the Port Centre.

The front car park will be illuminated by LED luminaires mounted on 6-meter poles. The rear car park will be illuminated by LED luminaires mounted on 8-meter poles.

The Boat Yard will be illuminated by LED flood lights mounted on 12-meter poles.

The Seafarer's Memorial will be illuminated by LED feature luminaires when more information is available on the memorial.

The Sunken Area will be provided with illumination by directional flood lights on the feature crane.

The Slipway will be illuminated from luminaires fitted to the handrail adjacent to the slipway on the upper quay side.



Figure 1 - Maritime Village

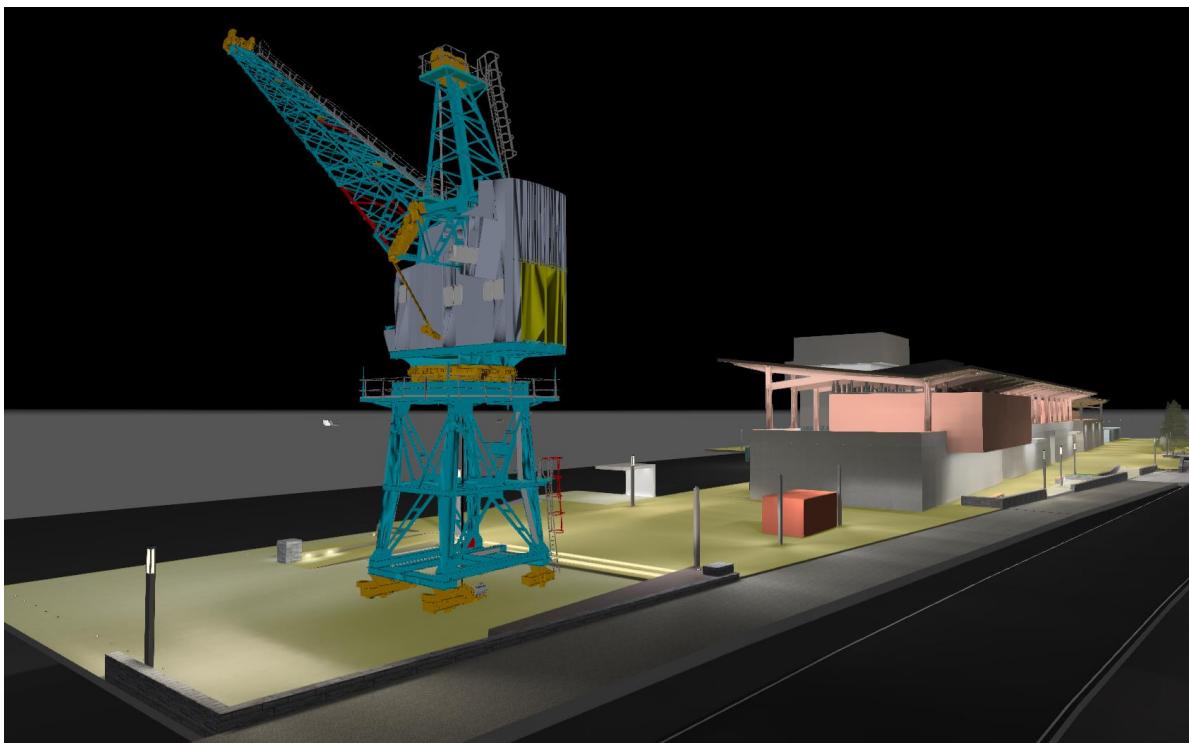


Figure 2 Maritime Village - Crane

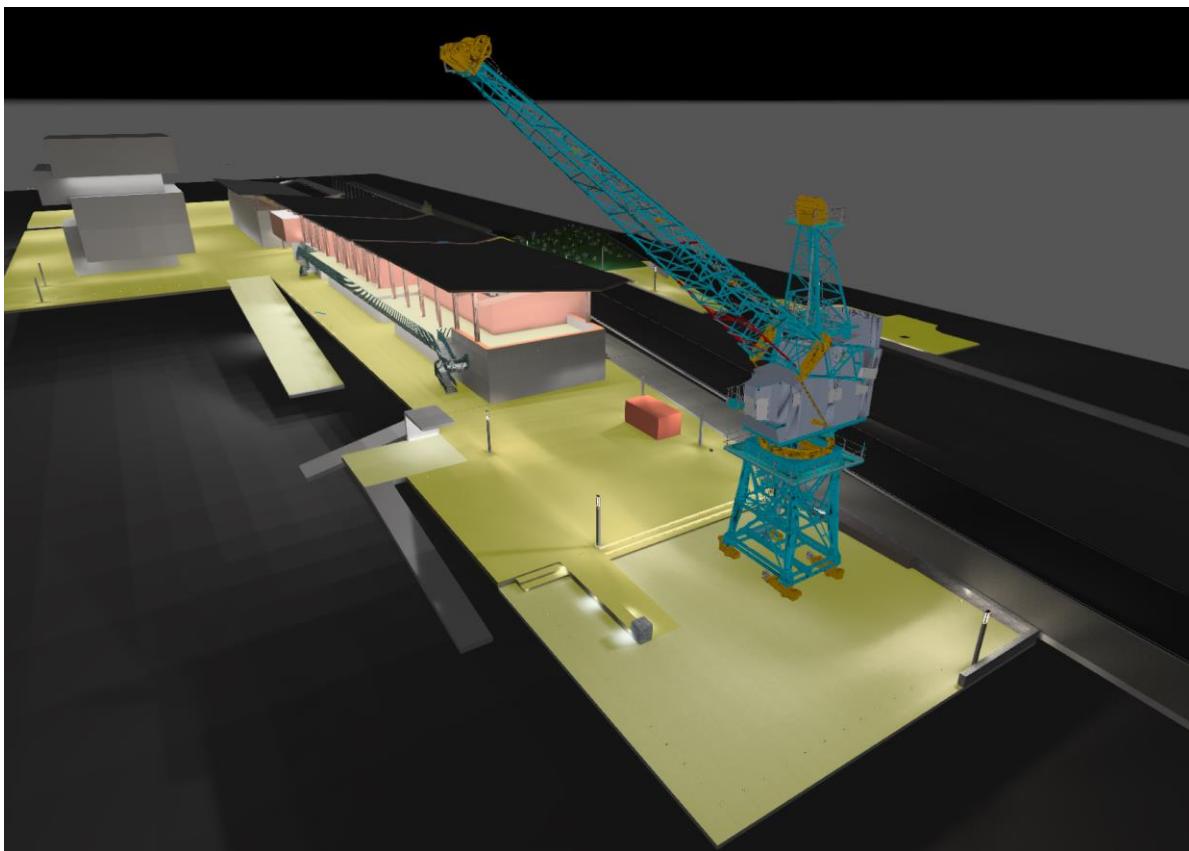


Figure 3 - Maritime Village - Sunken Area



Figure 4 - Maritime Village

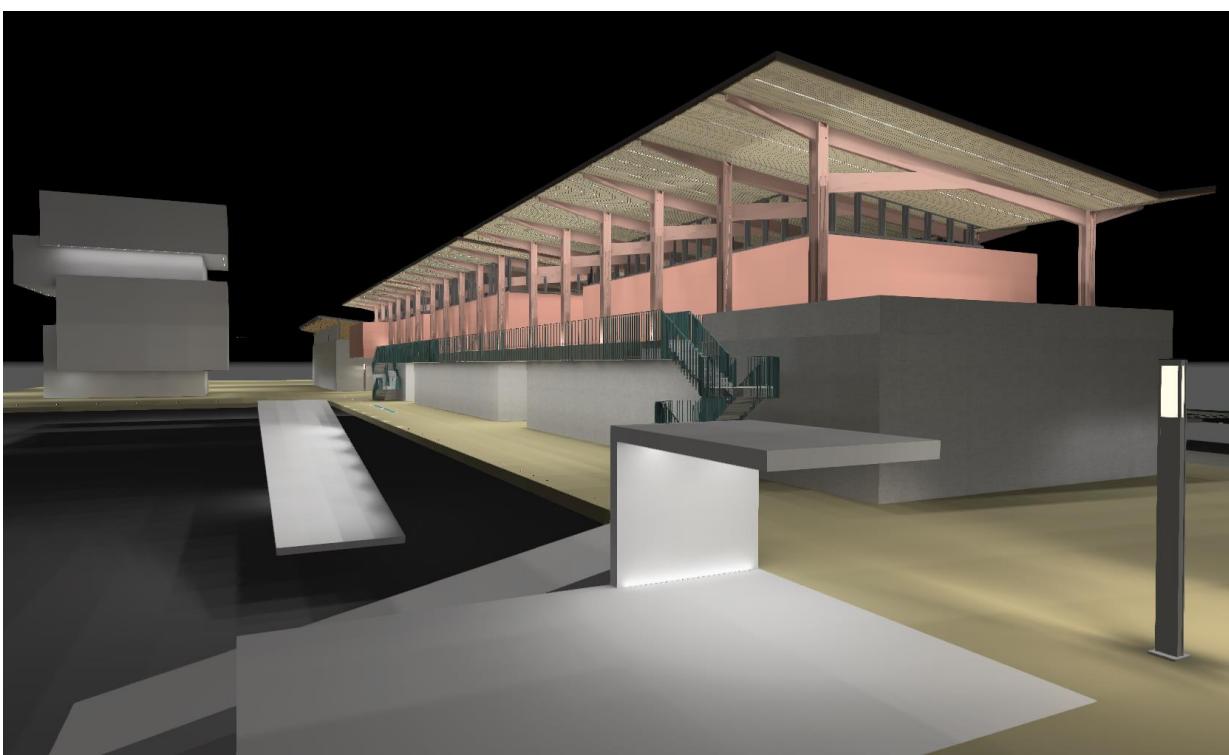


Figure 5 Maritime Village

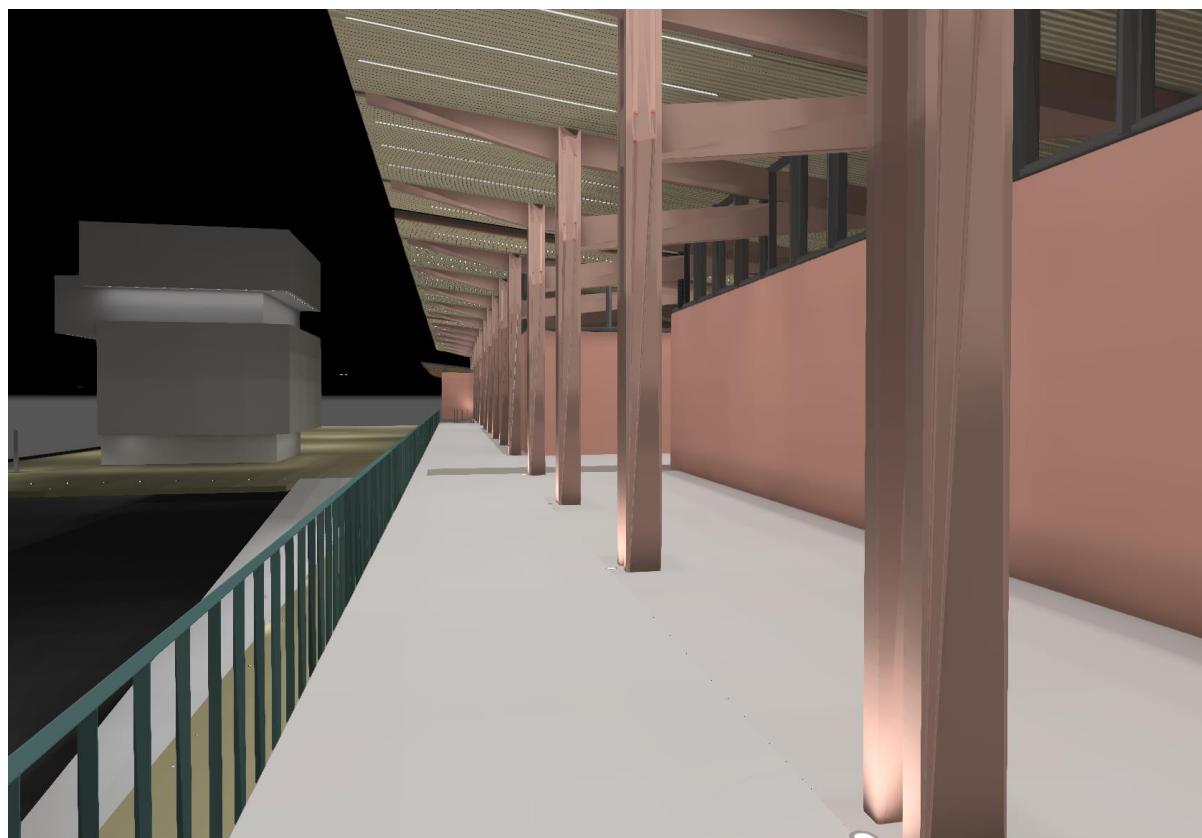


Figure 6 Maritime Village - Column Up-lights



Figure 7 - Maritime Village

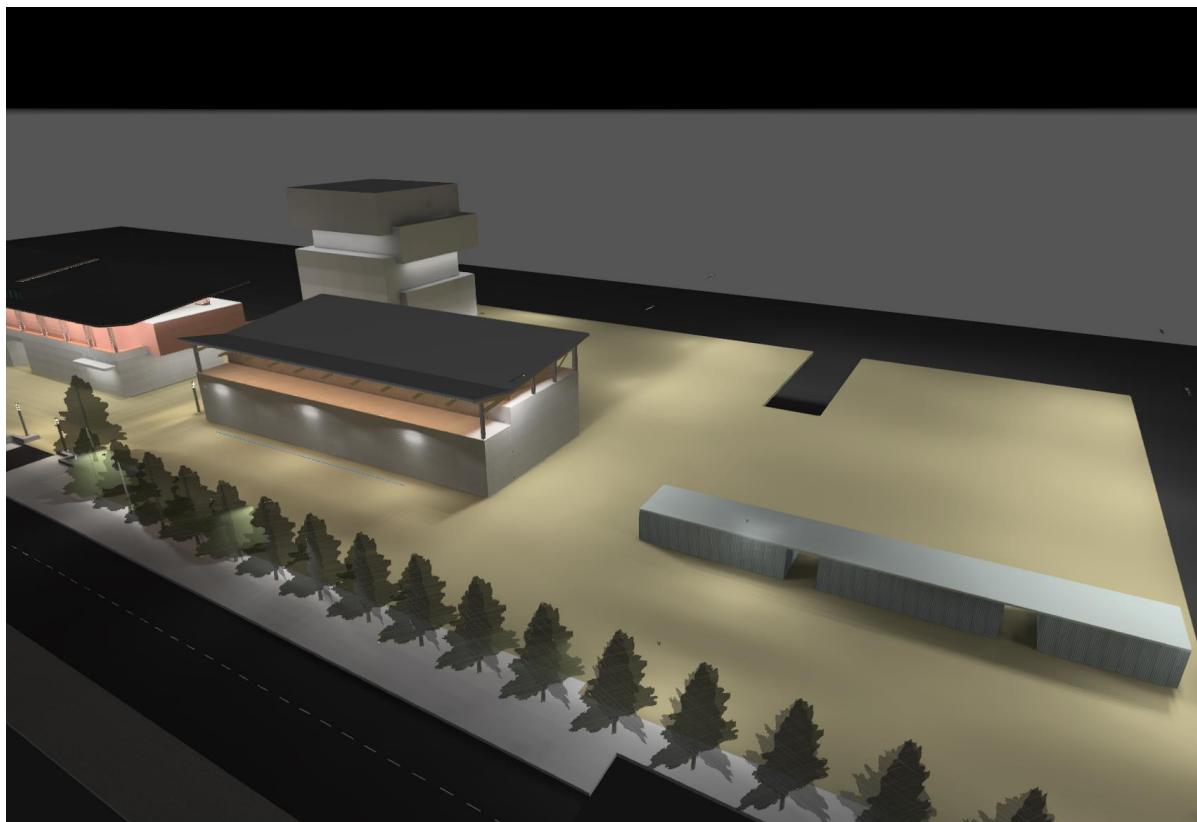


Figure 8 - Boat Maintenance Building & Yard



Figure 9 - Maritime Village


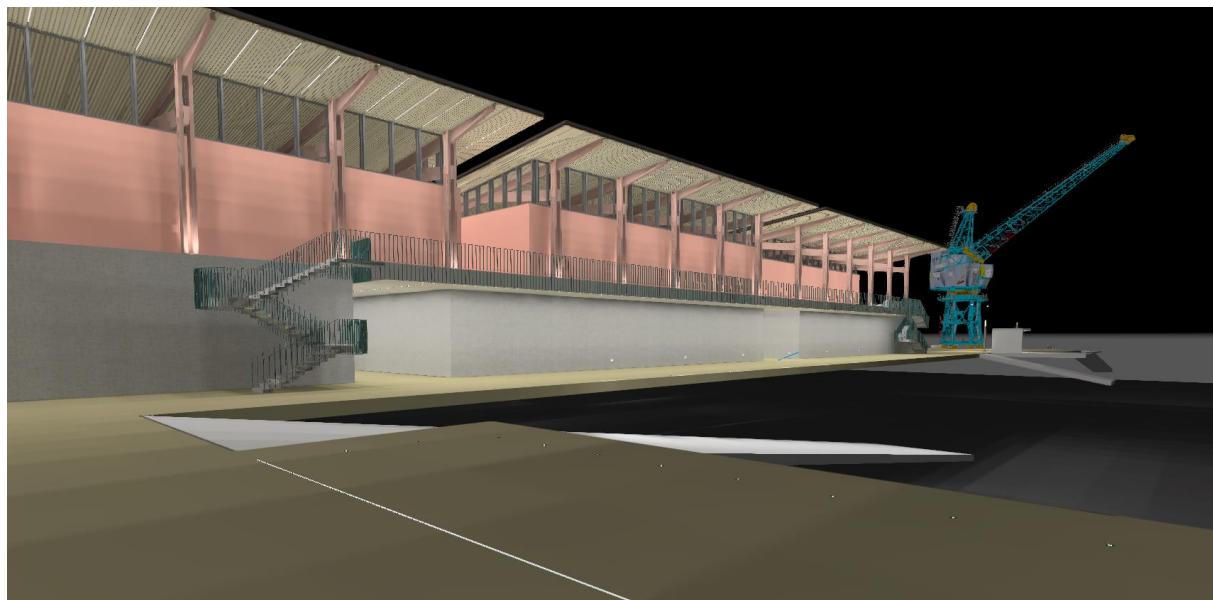


Figure 10 Maritime Village



Figure 11 Maritime Village

3.7 Proposed Luminaire Types

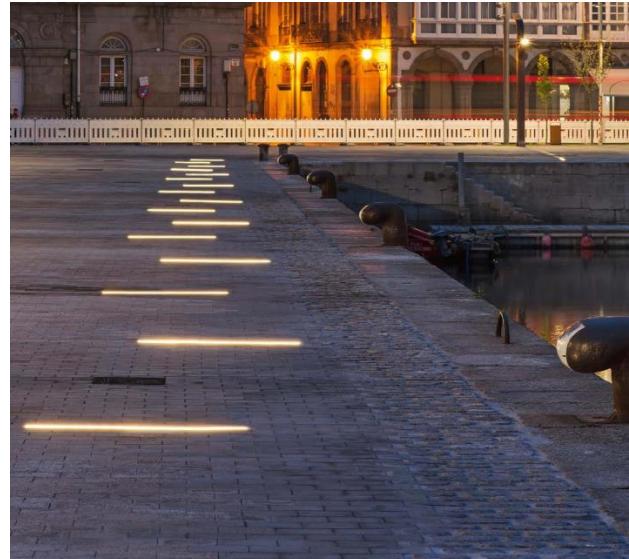

Rio - Luce & Light 2.4 IP67 IK10 - 2100mm x 37mm x 56mm

Location: Maritime Villiage – Underside of Roof and Balconies




Corso - Luce & Light 1.0 IP69 IK08 - 85mm x 108mm x 69mm

Location: Maritime Villiage - Guard Rail Up-Lighting



Corso - Luce & Light 3.0 IP69 IK08 - 148mm x 112mm x 124mm

Location: Maritime Villiage – Building Column Up-Lighting

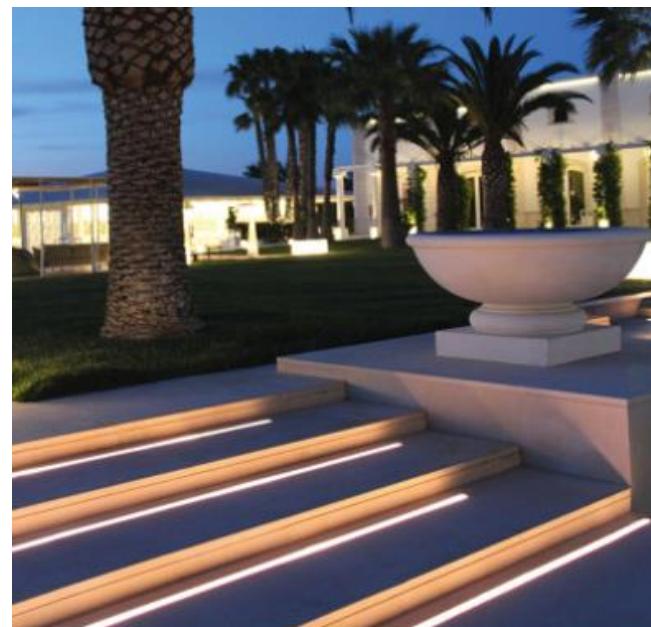

Rio - Luce & Light 1.3 IP67 IK10 - 1510mm x 20mm x 53mm

Location: Maritime Villiage – Inground Strip Lighting



Post-top version

Antina - Veelite IP66 IK08 - 600mm x 239mm x 60mm

Location: Maritime Villiage – Front Carpark



Metro Flood - Veelite IP66 IK08 - 427mm x 594mm x 94mm

Location: Maritime Villiage – Boatyard



Solo Area - Veelite IP66 - 600mm x 700mm x 193mm

Location: Maritime Villiage – Boatyard Carpark & Boatyard



Metro Streetlight - Veelite IP66 IK 09 - 625mm x 290mm x 105mm

Location: Maritime Villiage – Boatyard & Harbour Operations Building Carpark



Faro - Veelite IP65 IK 07 - 200mm x 200mm

Location: Maritime Villiage Slip way



Faro – Luce & Light IP66 IK 08 - 109mm x 179mm

Location: Maritime Villiage – Boat Maintenance Coloum Up-lighting



Mega Stage – Simes IP66 IK07 - 625mm x 290mm x 105mm

Location: Maritime Villiage – Public Event Space & Sunken Area – Crane Mounted



Proposed Crane Lighting will be similar to the Port Centre crane as above.

4.0 Appendix 1 – Drawing Register: Maritime Village Concept Lighting

JOB

3FM Project


JOB NUMBER

1036912

XXXX

Concept Lighting Drawings: Maritime Village		DATE OF ISSUE											
		DAY	1										
		MONTH	07										
		YEAR	24										
		FORMAT	E										
		P=POST D=CD E=EMAIL H=HAND F=FAX U=UPLOAD TO FTP/PROJECT DATA SITE											
DRAWING TITLE	DRAWING NUMBER	DRG SIZE	SCALE	REVISION									
Maritime Village Drawings													
Maritime Village - Concept Lighting Design - Sheet 1 of 6	1036912-CDL-ZZ-00-DR-E-39010	A1	1:200	PL01									
Maritime Village - Concept Lighting Design - Sheet 2 of 6	1036912-CDL-ZZ-00-DR-E-39011	A1	1:200	PL01									
Maritime Village - Concept Lighting Design - Sheet 5 of 6	1036912-CDL-ZZ-01-DR-E-39010	A1	1:200	PL01									
Maritime Village - Concept Lighting Design - Calculation Surface - Sheet 3 of 6	1036912-CDL-ZZ-00-DR-E-39012	A1	1:200	PL01									
Maritime Village - Concept Lighting Design - Calculation Surface - Sheet 4 of 6	1036912-CDL-ZZ-00-DR-E-39013	A1	1:200	PL01									
Maritime Village - Concept Lighting Design - Calculation Surface - Sheet 6 of 6	1036912-CDL-ZZ-01-DR-E-39011	A1	1:200	PL01									
Maritime Village Documents													
3FM Project - Maritime Village - Concept Lighting Planning Report	3FM-CDL-ZZ-XX-RP-E-15201												
PURPOSE OF ISSUE I = INFORMATION, T = TENDER ISSUE, CI = CONSTRUCTION ISSUE, P = PRELIMINARY CT = CONTRACT A = AS BUILT FC = FOR COMMENT, PL = PLANNING		PL											
ISSUED TO:													
PLANNING AUTHORITY	AN BORD PLEÁNÁLA												
COPIES	DUBLIN CITY COUNCIL, DUBLIN PORT COMPANY												

5.0 Appendix 2 – Planning Drawings: Maritime Village Concept Lighting

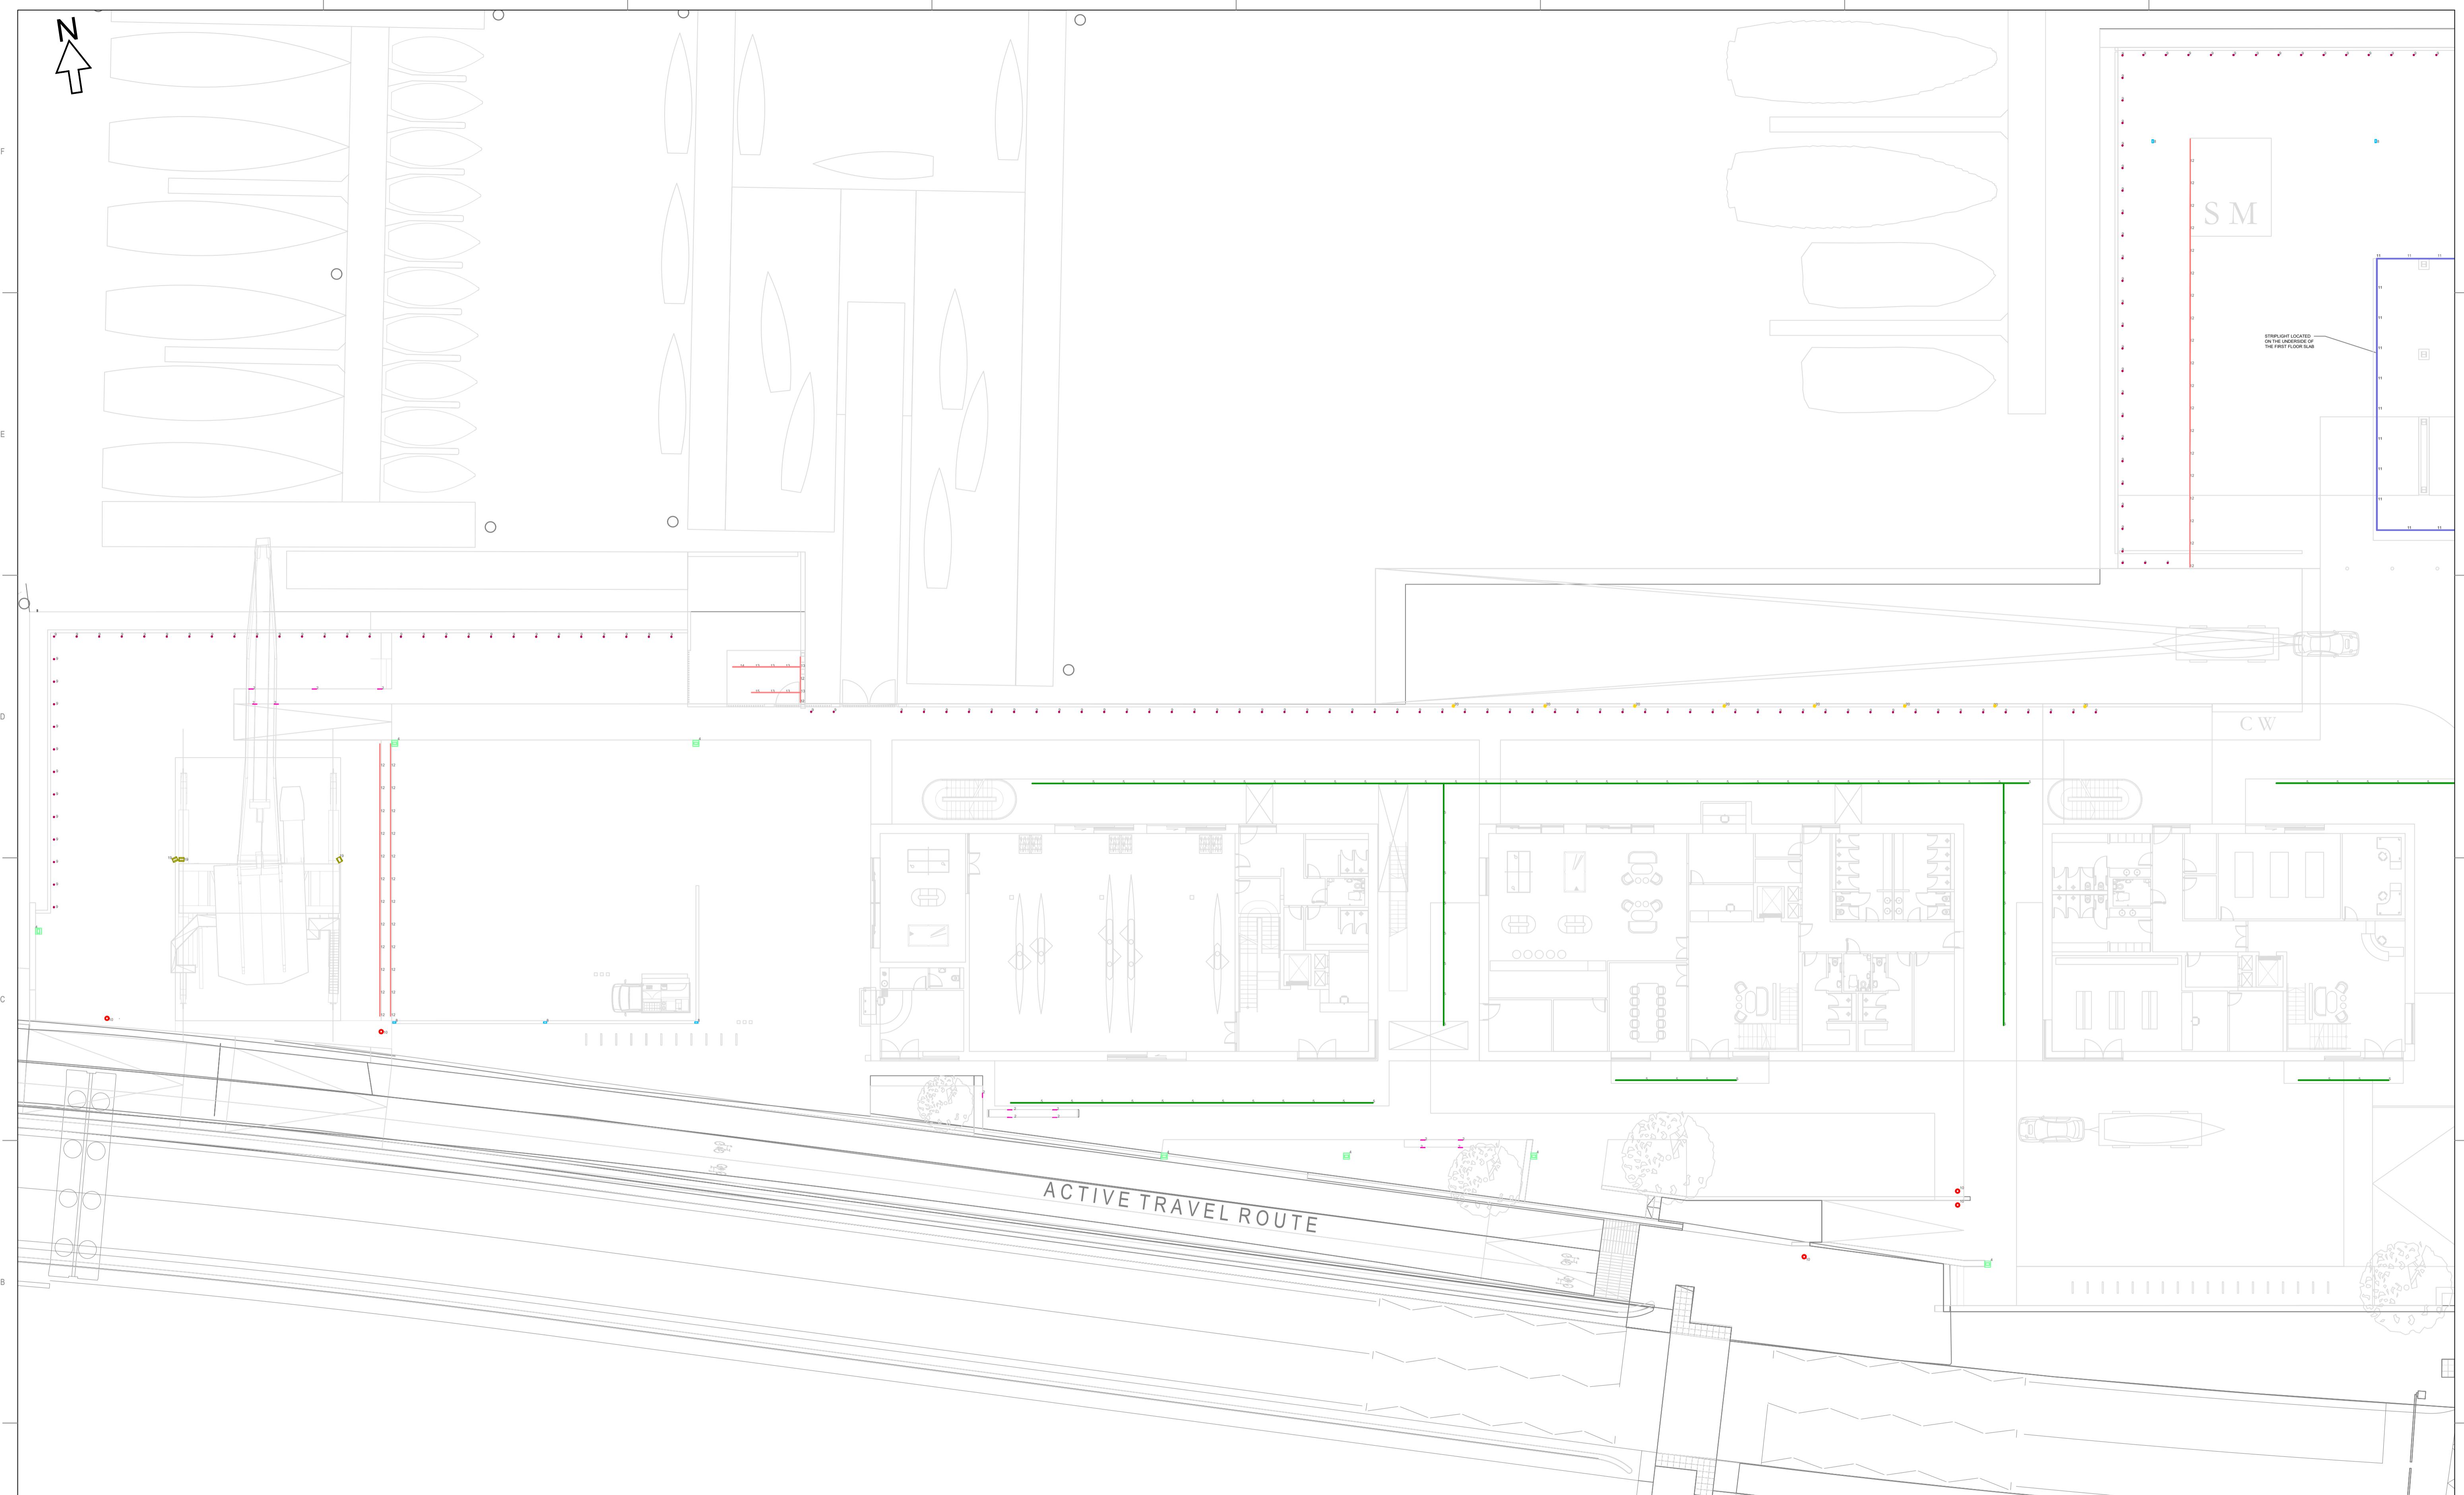


Based on:
Architects Drg No. Rev
Structural Drg No. Rev
Survey Drg No. Rev
Other Drg No. Rev
Other Drg No. Rev

THIS DRAWING MAY INDICATE ELEMENTS RELATED TO FIRE SYSTEMS.
THESE ARE INDICATIVE ONLY AND FINAL NUMBER, POSITIONING AND
PERFORMANCE MUST BE ESTABLISHED AS PART OF THE CDP WORKS
TO MAINTAIN THE INTENT OF THE DESIGN FIRE STRATEGY

A1

NOTES:

1. THIS DRAWING SHALL BE READ IN CONJUNCTION WITH ALL RELEVANT ARCHITECTURAL, STRUCTURAL AND ENGINEERING SERVICES DRAWINGS, SPECIFICATIONS, SCHEDULES AND PROJECT SPECIFIC DOCUMENTS.
2. ALL PLANT AND EQUIPMENT IS TO BE INSTALLED TO MANUFACTURER'S RECOMMENDATIONS, ALLOWING FULL ACCESS FOR COMMISSIONING, MAINTENANCE AND REMOVAL/REPLACEMENT.
3. ALL DIMENSIONS in mm UNLESS OTHERWISE STATED.
4. DO NOT SCALE FROM THIS DRAWING.
5. FOR SYMBOLS SEE DRAWING XXXX(XX)XXXX.

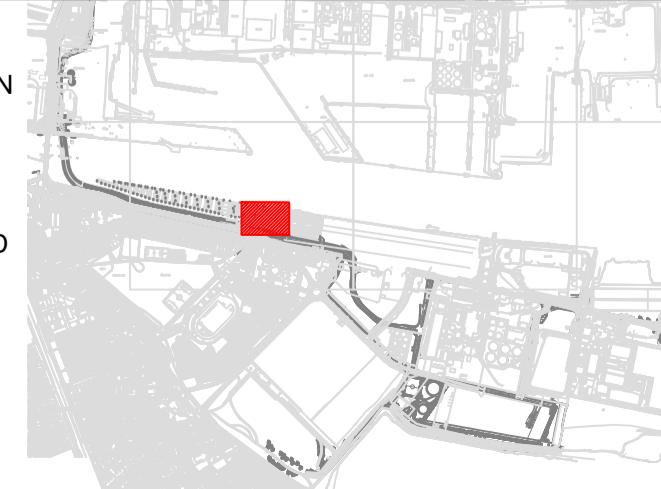

MARITIME VILLAGE LEGEND:

- CORSO 3.0
- SIMES S.P.A. GHOST RECESSED WALL LIGHT
- SPOT 4.4
- RENO HESS POLE LIGHT 180 DEGREES
- RIO UNDER BALCONY STRIP LIGHT
- ATTINA STREET LIGHT
- METRO COOLIGHT
- RIO ELEMENTS HESS POLE LIGHT 360 DEGREES
- CORSO 1.0
- STRA 2.0 INGROUND UPLIGHT
- RIO 2.4D 34W RGB
- RIO INGROUND STRIP LIGHT - 1510mm
- RIO INGROUND STRIP LIGHT - 1010mm
- RIO INGROUND STRIP LIGHT - 510mm
- RIO INGROUND STRIP LIGHT - 260mm
- KASSO BOLLARD
- METRO STREET LIGHT
- SOLO AREA LIGHT
- MEGASTAGE LED OSRAM DURIS S5
- FARO LED WIDE BEAM
- LUX LEVEL ON SURFACE

PL01 | 01/07/24 | LIGHTING CONCEPT | GP | DK | WD

Issue

Date

Description

By

Chkd

Verfd

Project
3FM PROJECT

Client
DUBLIN PORT COMPANY LTD.

Drawing Status
PL01

Title
MARITIME VILLAGE CONCEPT LIGHTING DESIGN SHEET 1 OF 6


Project No. **1038937** | Scale **1:200**

Drawing No. **1036912-CDL-ZZ-00-DR-E-39010**

CUNDALL

2 Dawson Street,
Dublin, Ireland,
D02 VK75
Tel: +353 (0)1 513 7120

Website: www.cundall.com

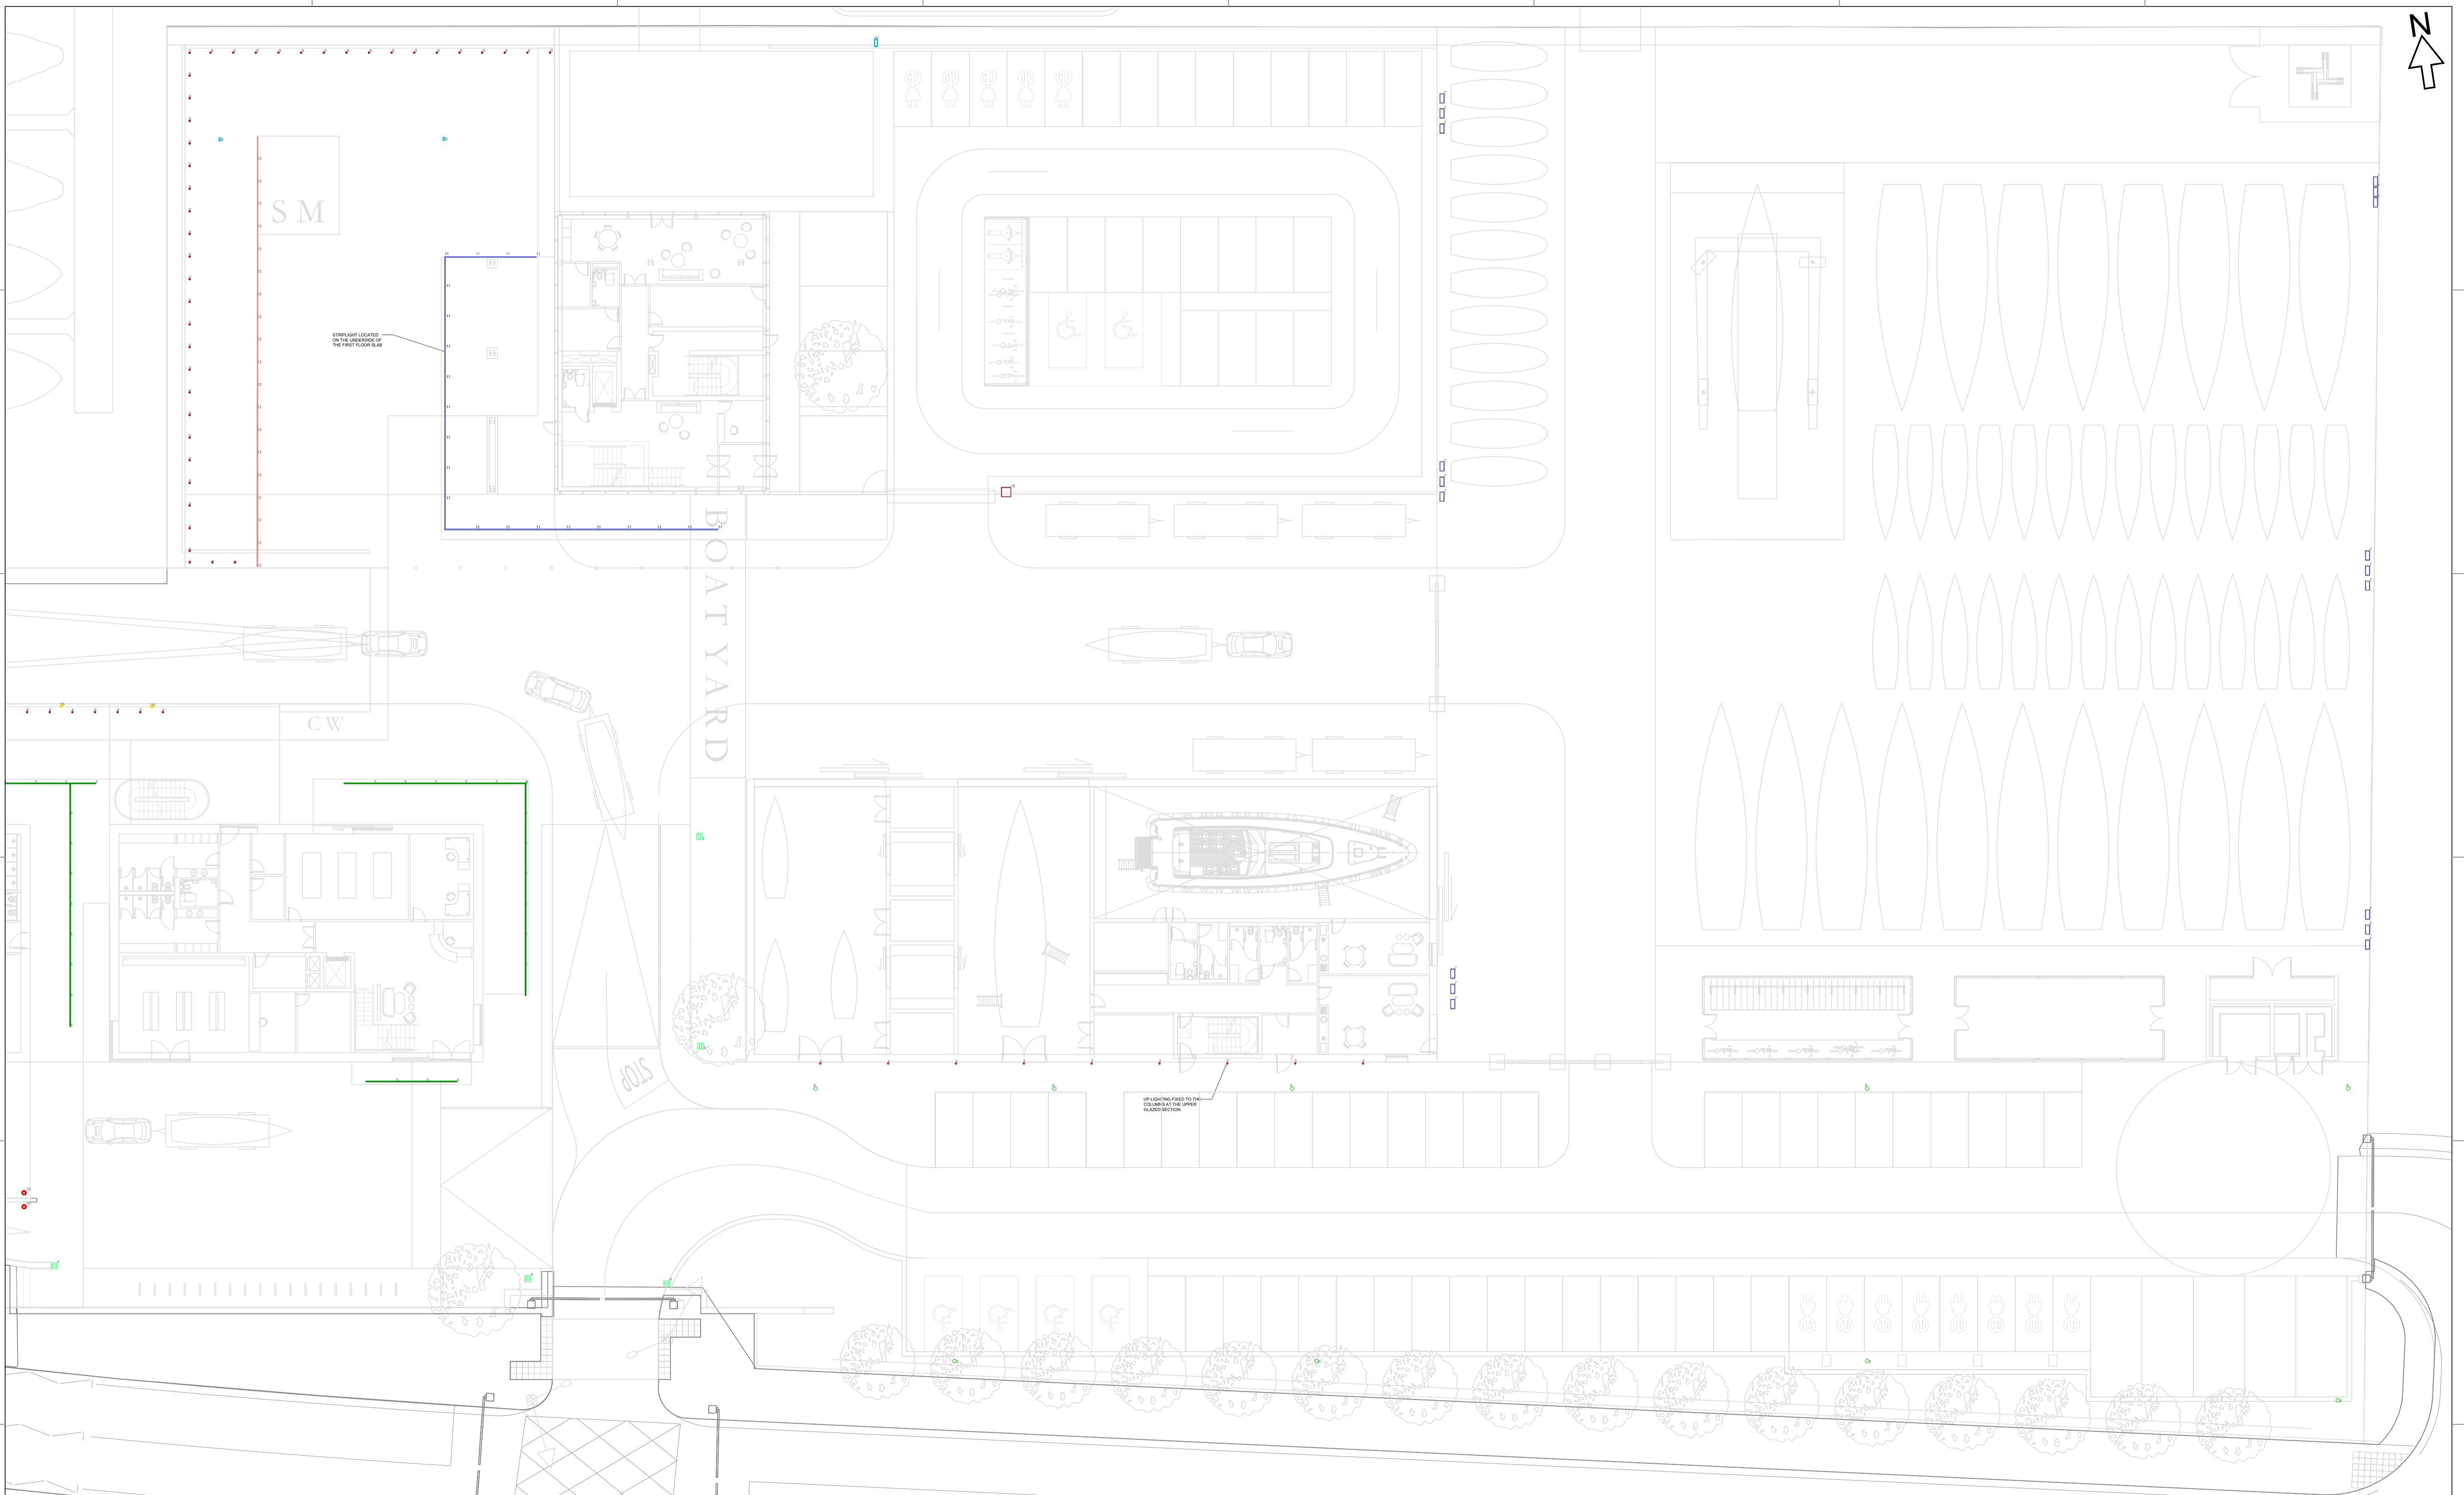

A1

NOTES:

1. THIS DRAWING SHALL BE READ IN CONJUNCTION WITH ALL RELEVANT ARCHITECTURAL, STRUCTURAL AND ENGINEERING SERVICES DRAWINGS, SPECIFICATIONS, SCHEDULES AND PROJECT SPECIFIC DOCUMENTS.
2. ALL PLANT AND EQUIPMENT IS TO BE INSTALLED TO MANUFACTURER'S RECOMMENDATIONS, ALLOWING FULL ACCESS FOR COMMISSIONING, MAINTENANCE AND REMOVAL/REPLACEMENT.
3. ALL DIMENSIONS in mm UNLESS OTHERWISE STATED.
4. DO NOT SCALE FROM THIS DRAWING.
5. FOR SYMBOLS SEE DRAWING XXXX(XX)XXXX.

Based on:
Architects Drg No.
Structural Drg No.
Survey Drg No.
Other Drg No.
Other Drg No.

Rev
Rev
Rev
Rev
Rev



MARITIME VILLAGE LEGEND:

- CORSO 3.0
- SIMES S.P.A. GHOST RECESSED WALL LIGHT
- △ SPOT 4.4
- RENO HESS POLE LIGHT 180 DEGREES
- RIO UNDER BALCONY STRIP LIGHT
- ATTINA STREET LIGHT
- METRO FLOODLIGHT
- RIO 180 DEGREES HESS POLE LIGHT 360 DEGREES
- CORSO 1.0
- STRA 2.0 INGROUND UPLIGHT

RIO 2.4D 34W RGB

- RIO INGROUND STRIP LIGHT - 1510mm
- RIO INGROUND STRIP LIGHT - 1010mm
- RIO INGROUND STRIP LIGHT - 510mm
- RIO INGROUND STRIP LIGHT - 260mm

KASSO BOLLARD

METRO STREET LIGHT

SOLO AREA LIGHT

MEGASTAGE LED OSRAM DURIS S5

FARO LED WIDE BEAM

LUX LEVEL ON SURFACE

Project
3FM PROJECT

Client
DUBLIN PORT COMPANY LTD.

Drawing Status
PL01

Title
MARITIME VILLAGE
CONCEPT LIGHTING DESIGN
SHEET 2 OF 6

Project No.
1038937


Scale
1:200

Drawing No.
1036912-CDL-ZZ-00-DR-E-39011

CUNDALL

2 Dawson Street,
Dublin, Ireland,
D02 VK75
Tel: +353 (0)1 513 7120


Website: www.cundall.com

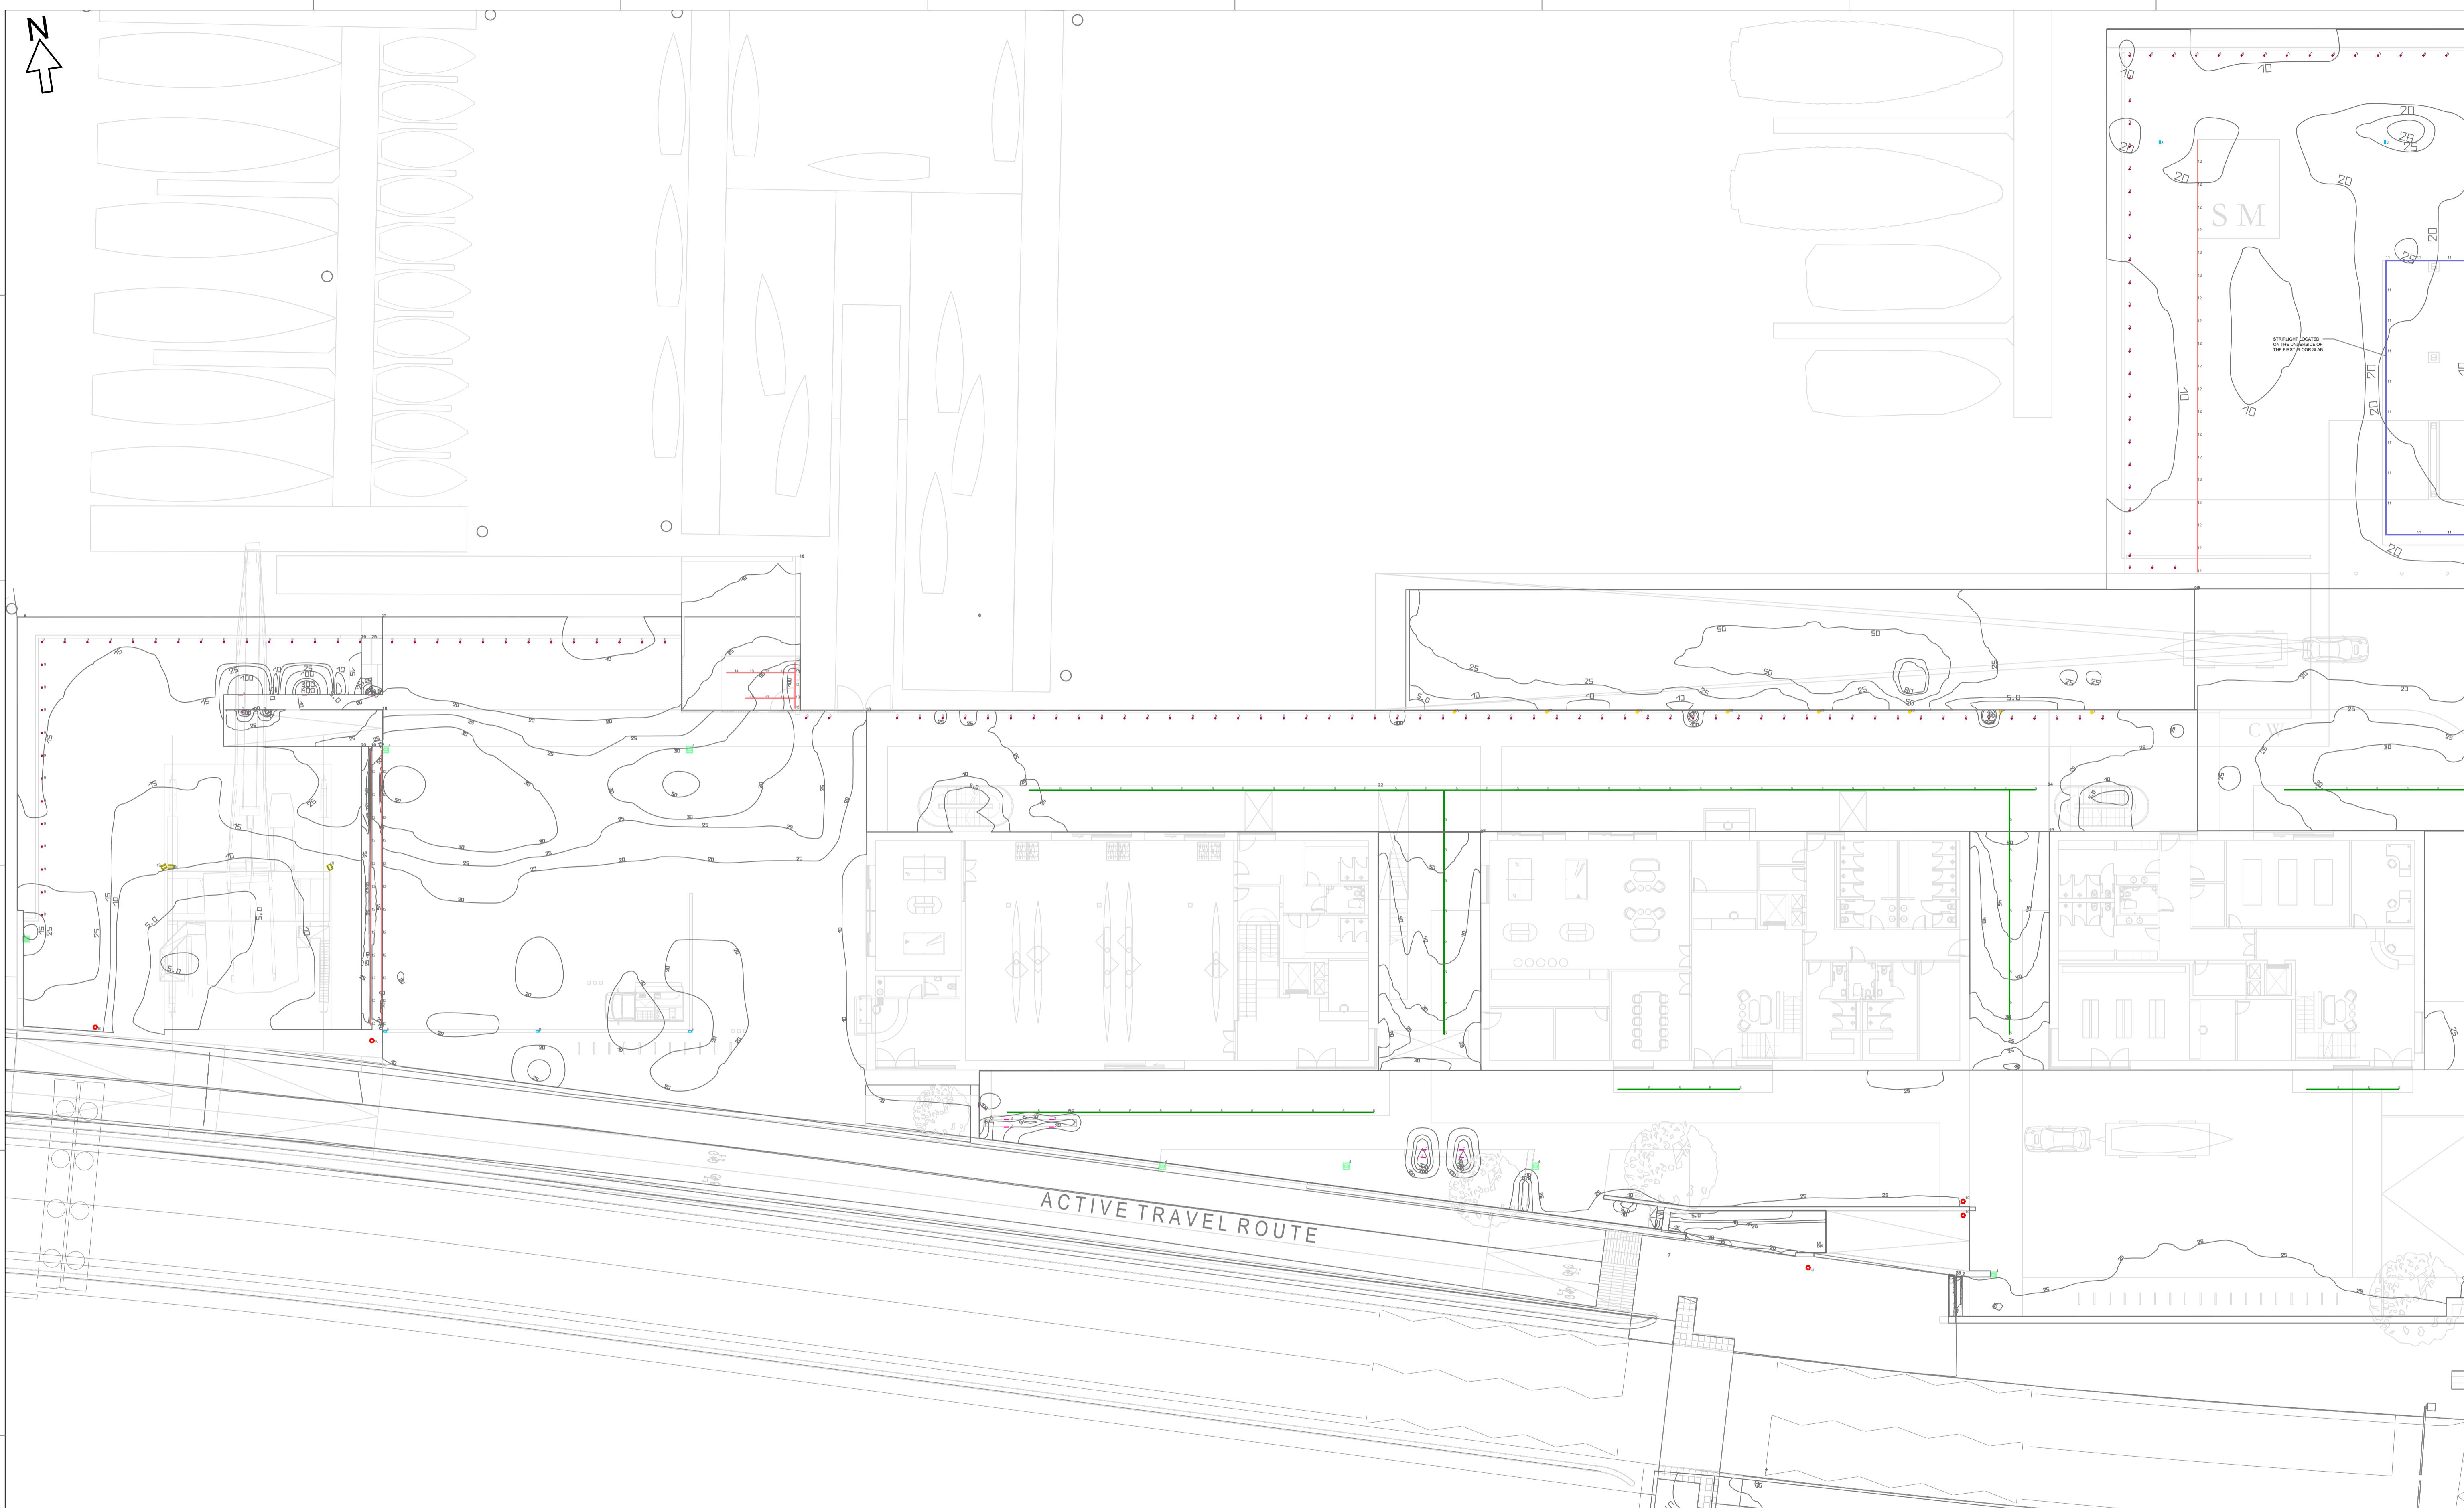

Based on: Architects Drg No. Structural Drg No. Survey Drg No. Other Drg No. Other Drg No.	Rev Rev Rev Rev Rev
THIS DRAWING MAY INDICATE ELEMENTS RELATED TO FIRE SYSTEMS. THESE ARE INDICATIVE ONLY AND FINAL NUMBER, POSITIONING AND PERFORMANCE MUST BE ESTABLISHED AS PART OF THE CDP WORKS TO MAINTAIN THE INTENT OF THE DESIGN FIRE STRATEGY	

A1

- NOTES:**
1. THIS DRAWING SHALL BE READ IN CONJUNCTION WITH ALL RELEVANT ARCHITECTURAL, STRUCTURAL AND ENGINEERING SERVICES DRAWINGS, SPECIFICATIONS, SCHEDULES AND PROJECT SPECIFIC DOCUMENTS.
 2. ALL PLANT AND EQUIPMENT IS TO BE INSTALLED TO MANUFACTURER'S RECOMMENDATIONS, ALLOWING FULL ACCESS FOR COMMISSIONING, MAINTENANCE AND REMOVAL/REPLACEMENT.
 3. ALL DIMENSIONS in mm UNLESS OTHERWISE STATED.
 4. DO NOT SCALE FROM THIS DRAWING.
 5. FOR SYMBOLS SEE DRAWING XXXX(XX)XXXX.

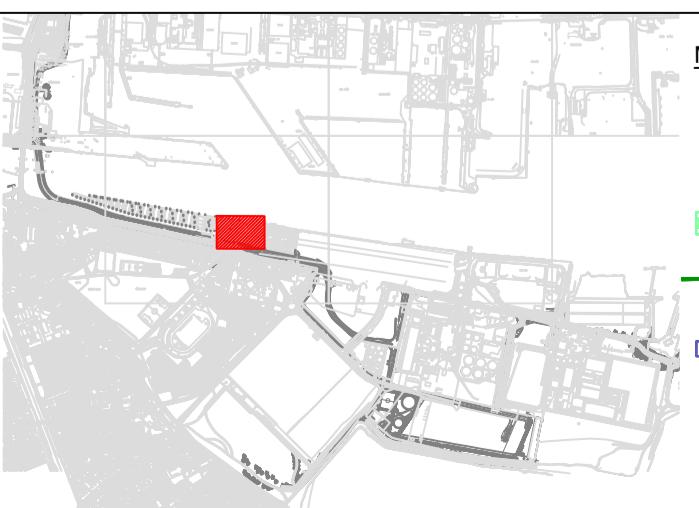

MARITIME VILLAGE LEGEND:


CORSO 3.0	RIO 2.4D 34W RGB
SIMES S.P.A. GHOST RECESSED WALL LIGHT	RIO INGROUND STRIP LIGHT - 1510mm
SPOT 4.4	RIO INGROUND STRIP LIGHT - 1010mm
RENO HESS POLE LIGHT 180 DEGREES	RIO INGROUND STRIP LIGHT - 510mm
ATINA STREET LIGHT	RIO INGROUND STRIP LIGHT - 260mm
METRO FLOODLIGHT	KASSO BOLLARD
RIO 2.4D 34W RGB POLE LIGHT 360 DEGREES	METRO STREET LIGHT
CORSO 1.0	SOLO AREA LIGHT
STRA 2.0 INGROUND UPLIGHT	MEGASTAGE LED OSRAM DURIS S5
	FARO LED WIDE BEAM
	LUX LEVEL ON SURFACE

Project	3FM PROJECT		
Client	DUBLIN PORT COMPANY LTD.		
Issue	Date	Description	By Chkd Verfd
PL01	01/07/24	LIGHTING CONCEPT	GP DK WD

Project	3FM PROJECT		
Client	DUBLIN PORT COMPANY LTD.		
Issue	Date	Description	By Chkd Verfd
PL01	01/07/24	LIGHTING CONCEPT	GP DK WD

Title	MARITIME VILLAGE CONCEPT LIGHTING DESIGN CALCULATION SURFACE SHEET 3 OF 6	
Project No.	1038937	Scale 1:200
Drawing No.	1036912-CDL-ZZ-00-DR-E-39012	

CUNDALL
2 Dawson Street,
Dublin, Ireland,
D02 VK75
Tel: +353 (0)1 513 7120
Website: www.cundall.com

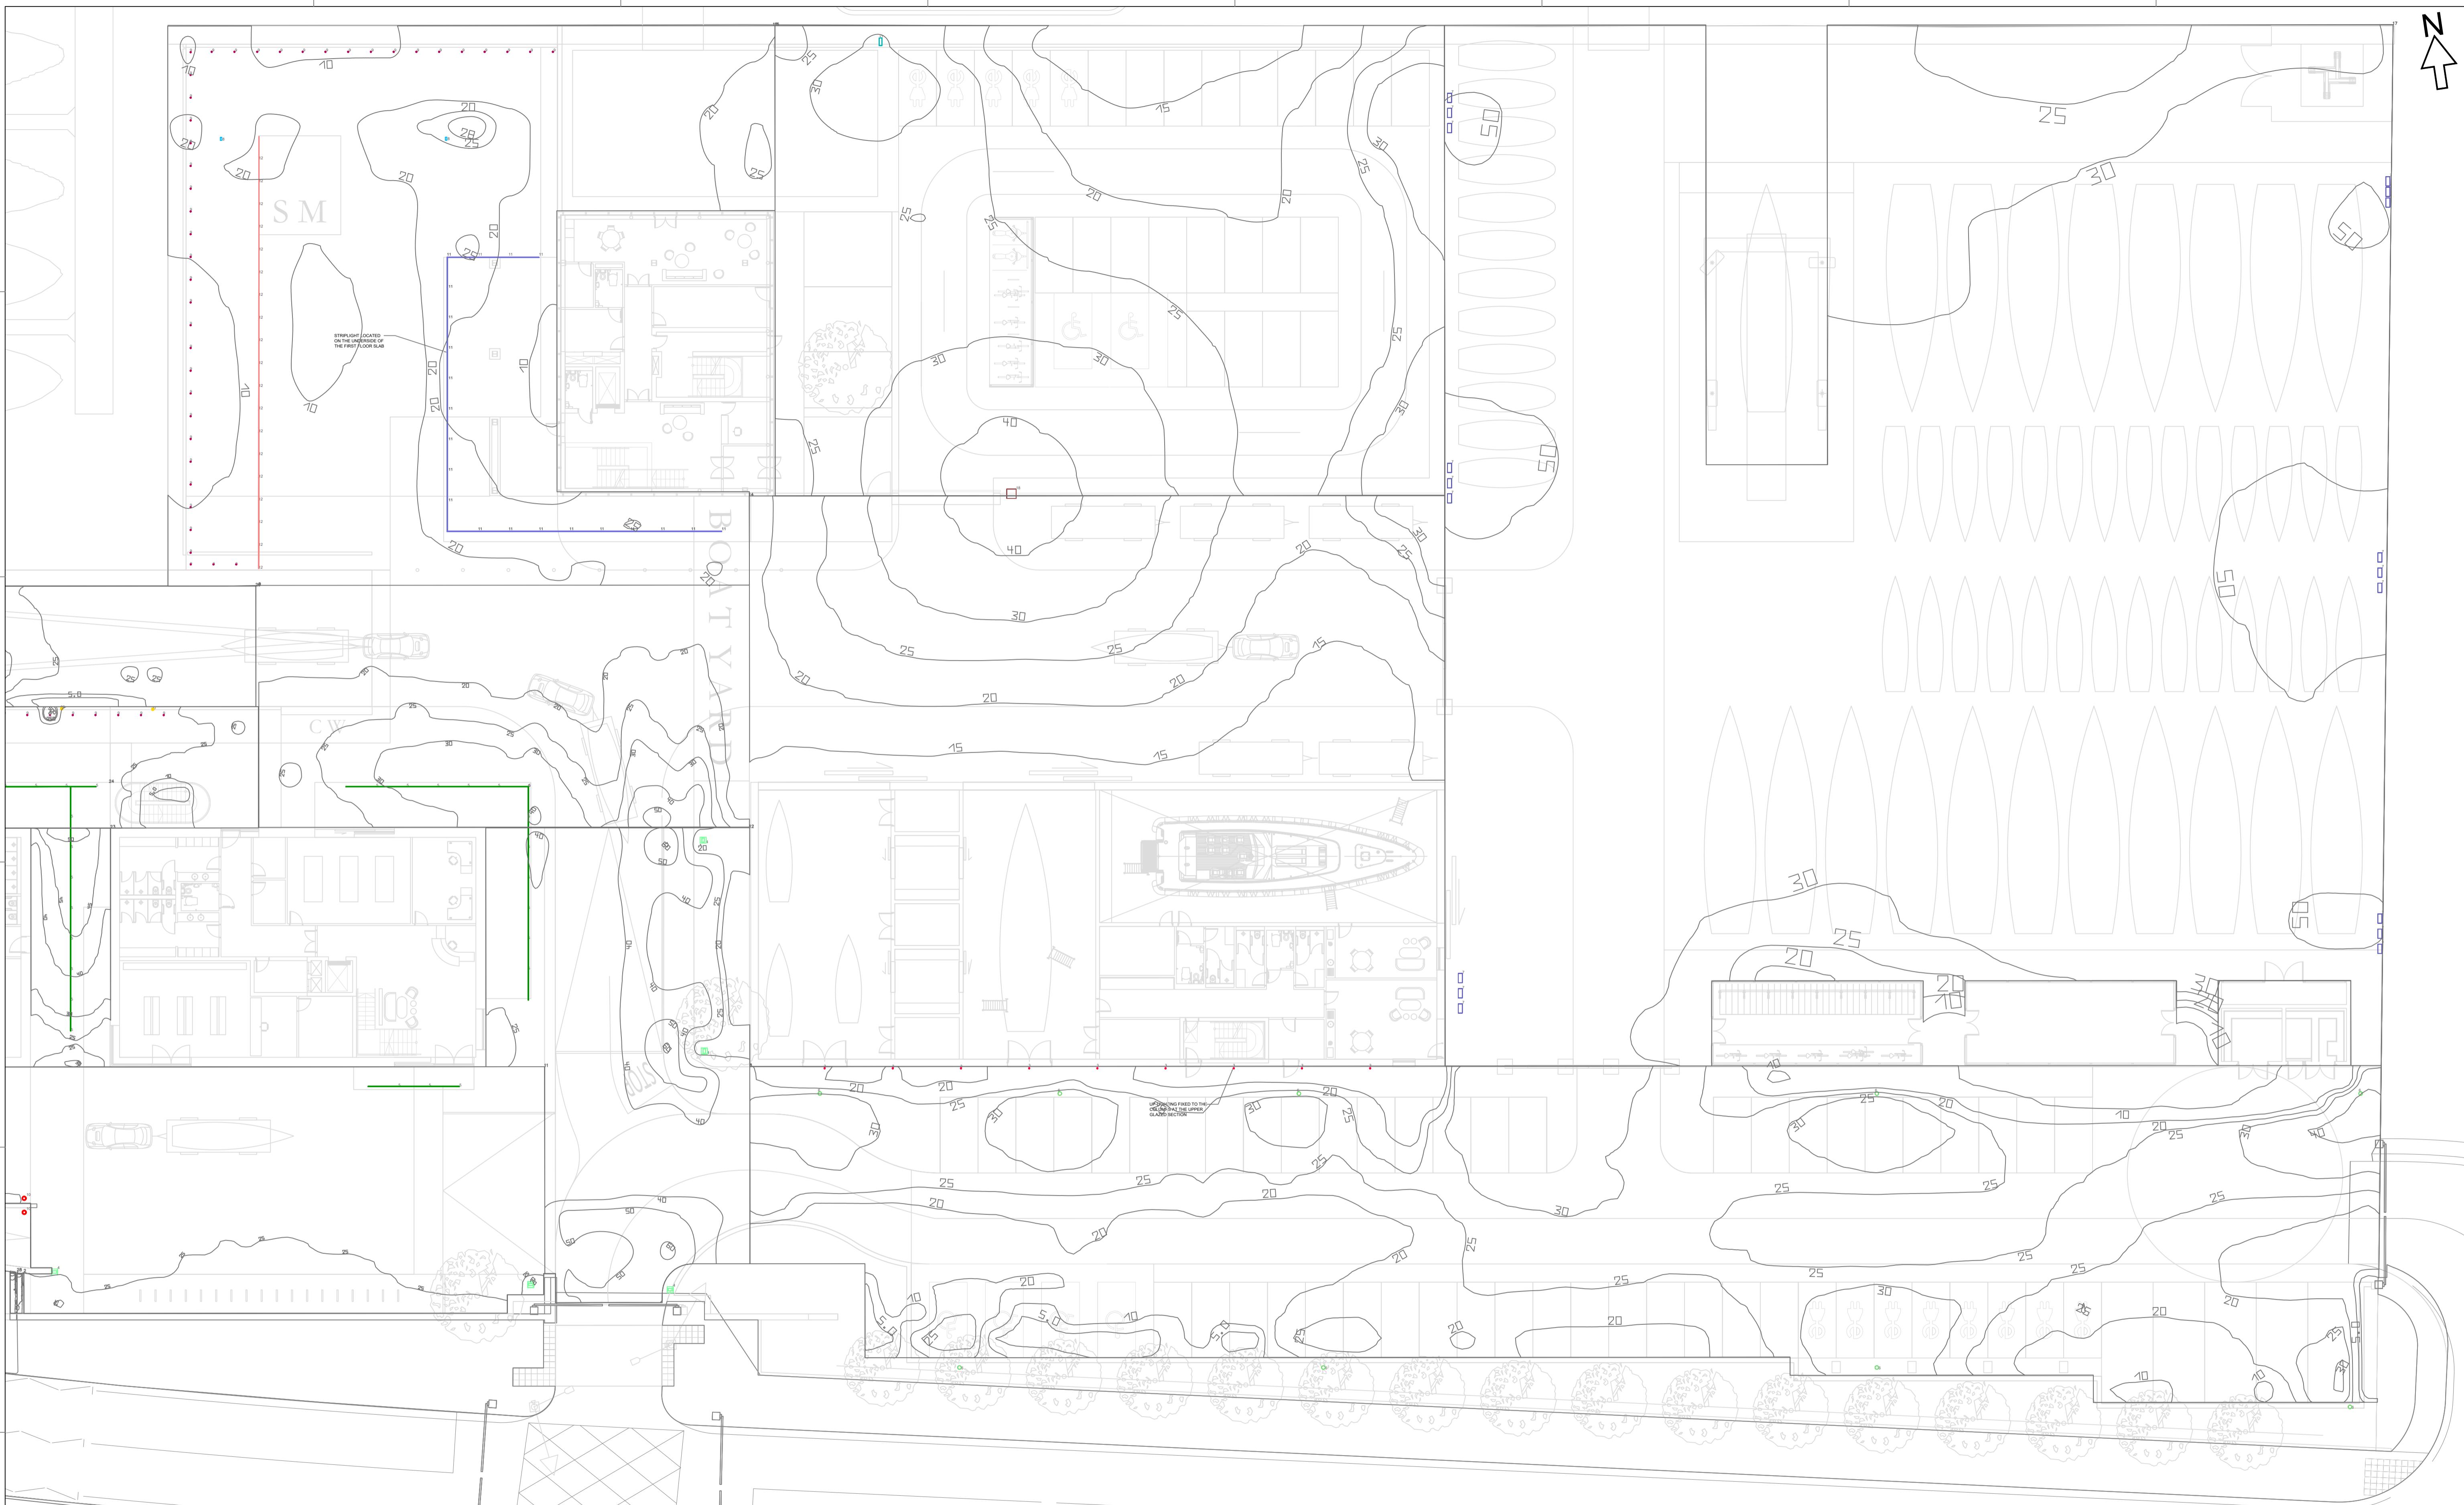


A1

NOTES:

- THIS DRAWING SHALL BE READ IN CONJUNCTION WITH ALL RELEVANT ARCHITECTURAL, STRUCTURAL AND ENGINEERING SERVICES DRAWINGS, SPECIFICATIONS, SCHEDULES AND PROJECT SPECIFIC DOCUMENTS.
- ALL PLANT AND EQUIPMENT IS TO BE INSTALLED TO MANUFACTURER'S RECOMMENDATIONS, ALLOWING FULL ACCESS FOR COMMISSIONING, MAINTENANCE AND REMOVAL/REPLACEMENT.
- ALL DIMENSIONS in mm UNLESS OTHERWISE STATED.
- DO NOT SCALE FROM THIS DRAWING.
- FOR SYMBOLS SEE DRAWING XXXX(XX)XXXX.

Based on:
Architects Drg No.
Structural Drg No.
Survey Drg No.
Other Drg No.
Other Drg No.

Rev
Rev
Rev
Rev
Rev

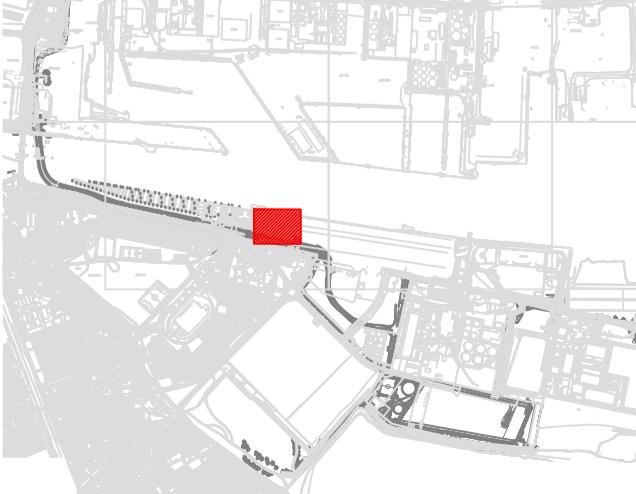

MARITIME VILLAGE LEGEND:	
CORSO 3.0	RIO 2.4D 34W RGB
SIMES S.P.A. GHOST RECESSED WALL LIGHT	RIO INGROUND STRIP LIGHT - 1510mm
SPOT 4.4	RIO INGROUND STRIP LIGHT - 1010mm
RENO HESS POLE LIGHT 180 DEGREES	RIO INGROUND STRIP LIGHT - 510mm
RIO UNDER BALCONY STRIP LIGHT	RIO INGROUND STRIP LIGHT - 260mm
ATTINA STREET LIGHT	KASSIO BOLLARD
METRO FLOODLIGHT	METRO STREET LIGHT
RENO HESS POLE LIGHT 360 DEGREES	SOLO AREA LIGHT
CORSO 1.0	MEGASTAGE LED OSRAM DURIS S5
STRA 2.0 INGROUND UPLIGHT	FARO LED WIDE BEAM
	LUX LEVEL ON SURFACE

PL01 01/07/24 LIGHTING CONCEPT GP DK WD
Issue Date Description By Chkd Verfd

Project
3FM PROJECT

Client
DUBLIN PORT COMPANY LTD.

Drawing Status
PL01

Title
MARITIME VILLAGE
CONCEPT LIGHTING DESIGN
CALCULATION SURFACE
SHEET 4 OF 6


Project No.
1038937 Scale
1:200

Drawing No.
1036912-CDL-ZZ-00-DR-E-39013

CUNDALL

2 Dawson Street,
Dublin, Ireland,
D02 VK75
Tel: +353 (0)1 513 7120

Website: www.cundall.com

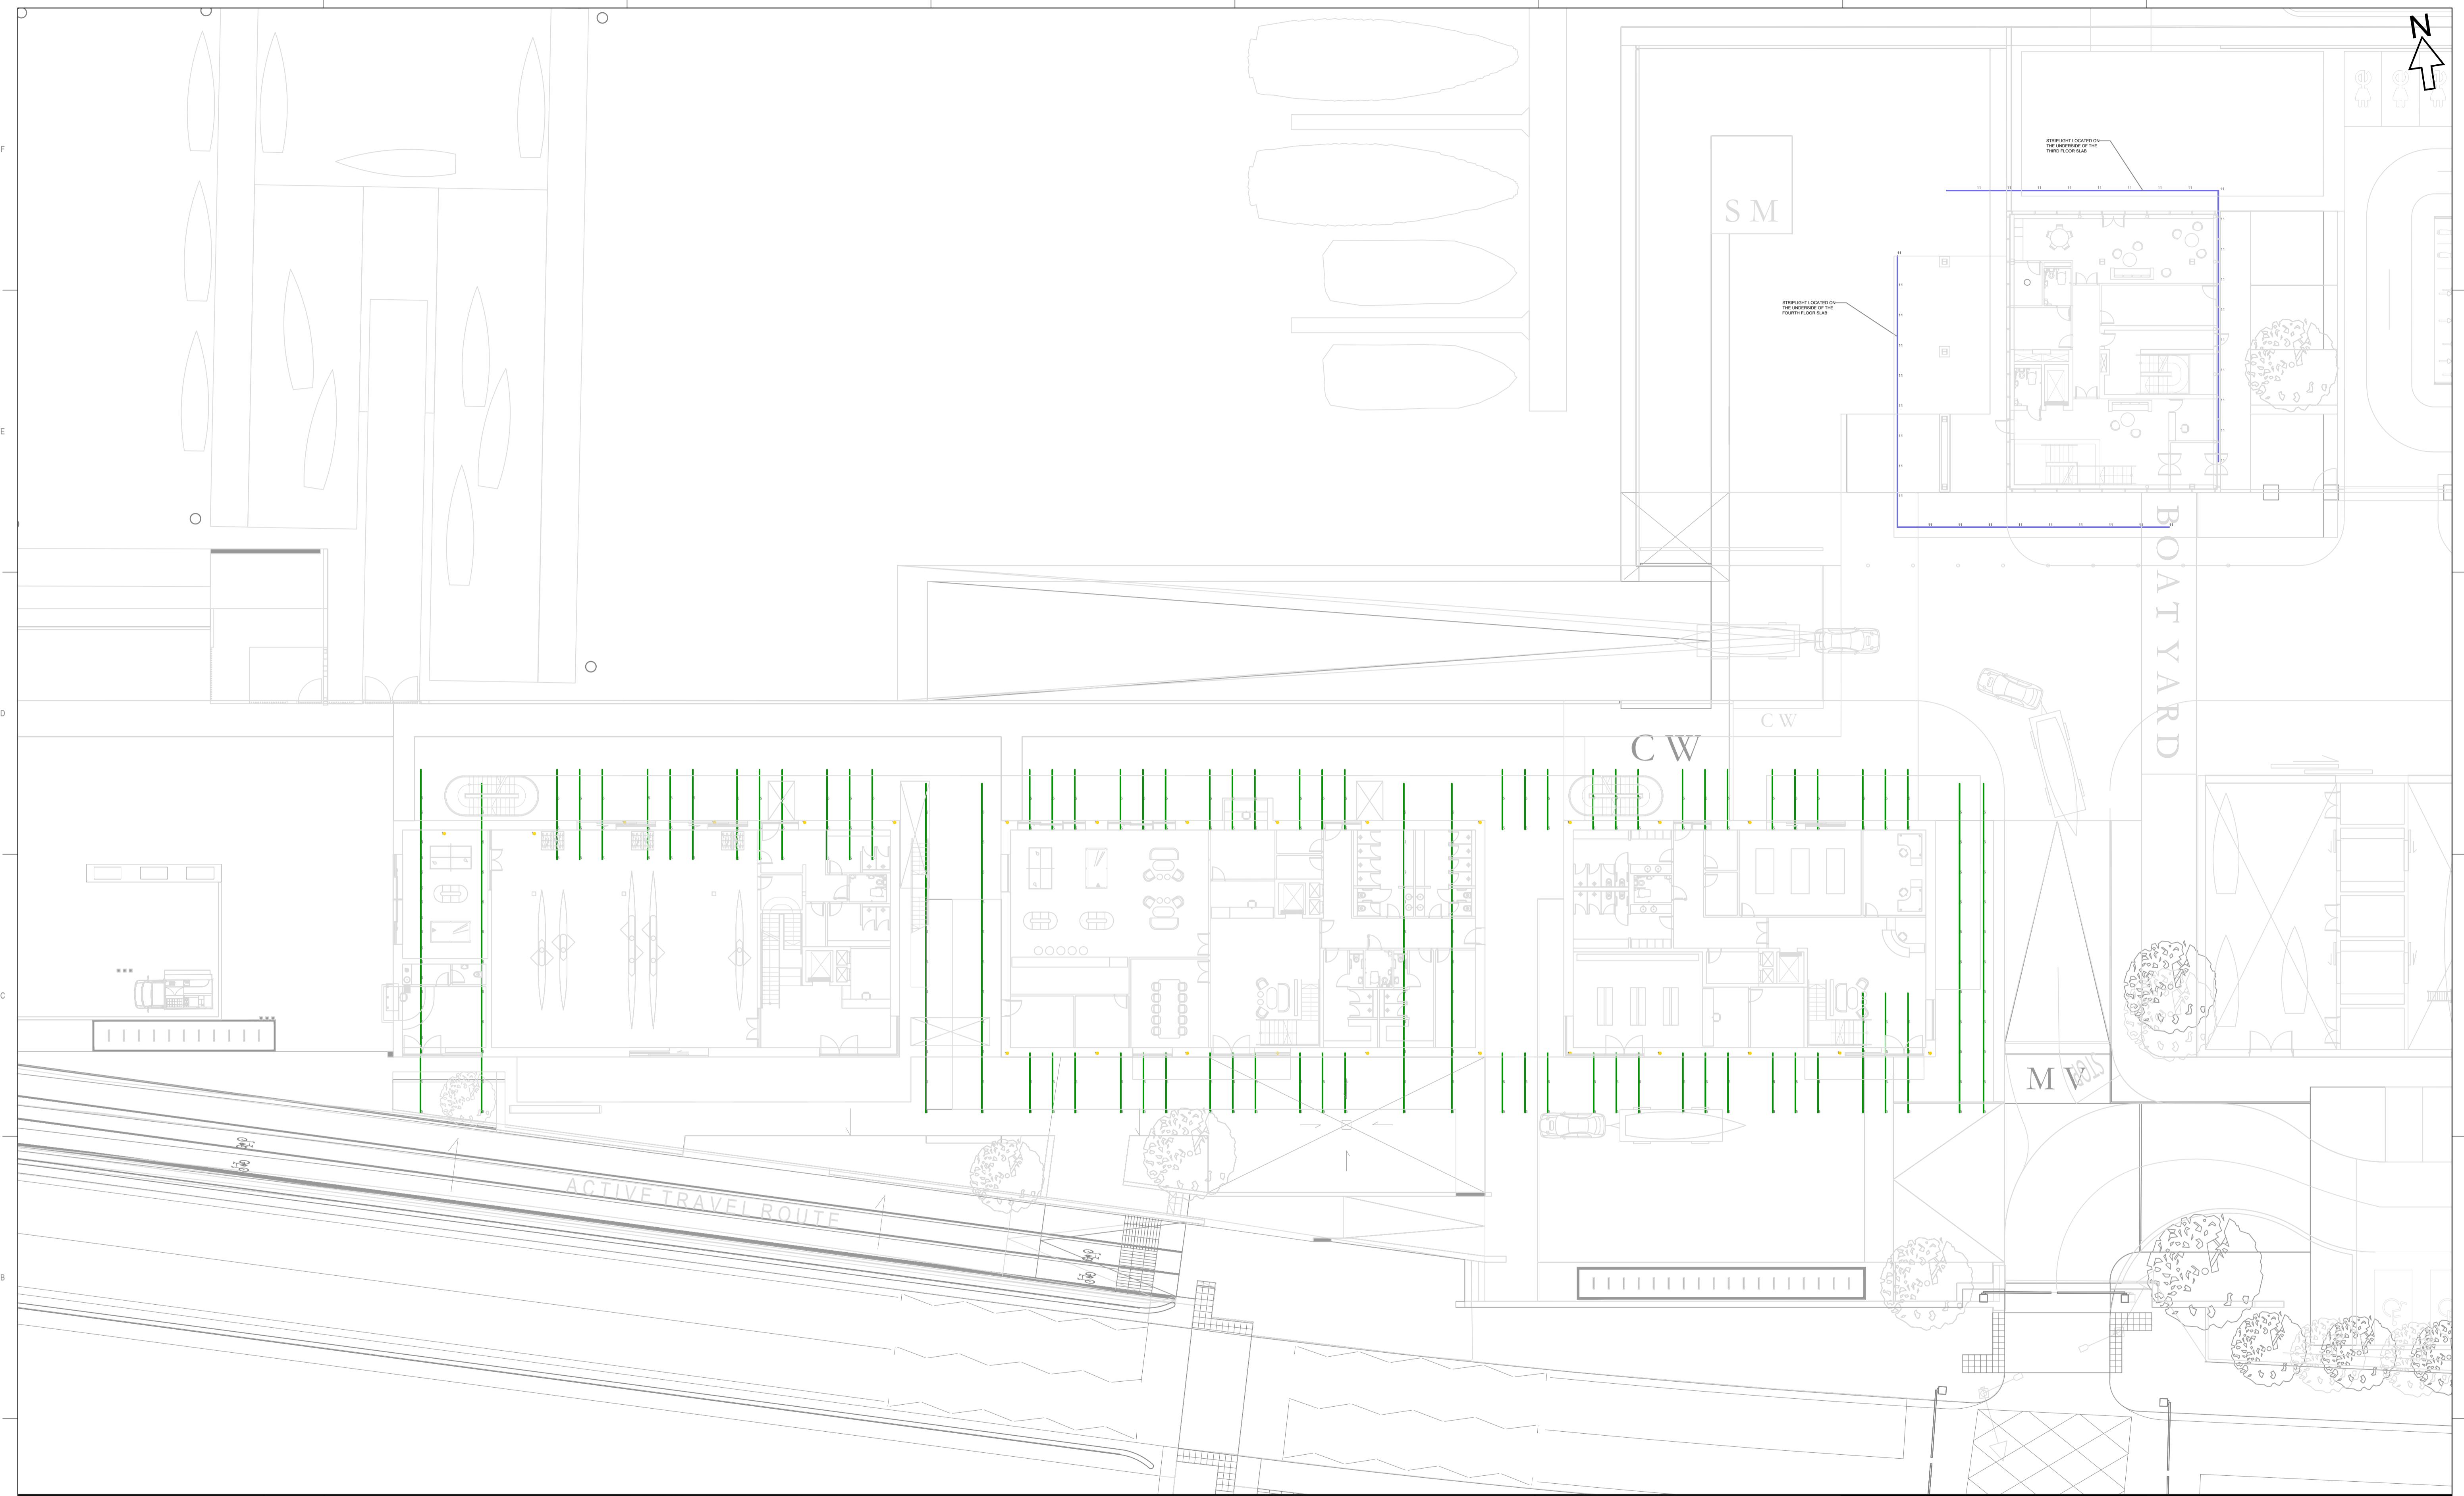


Based on: Architects Drg No. Structural Drg No. Survey Drg No. Other Drg No. Other Drg No.	Rev Rev Rev Rev Rev
THIS DRAWING MAY INDICATE ELEMENTS RELATED TO FIRE SYSTEMS. THESE ARE INDICATIVE ONLY AND FINAL NUMBER, POSITIONING AND PERFORMANCE MUST BE ESTABLISHED AS PART OF THE CDP WORKS TO MAINTAIN THE INTENT OF THE DESIGN FIRE STRATEGY	

A1

NOTES:

1. THIS DRAWING SHALL BE READ IN CONJUNCTION WITH ALL RELEVANT ARCHITECTURAL, STRUCTURAL AND ENGINEERING SERVICES DRAWINGS, SPECIFICATIONS, SCHEDULES AND PROJECT SPECIFIC DOCUMENTS.
2. ALL PLANT AND EQUIPMENT IS TO BE INSTALLED TO MANUFACTURER'S RECOMMENDATIONS, ALLOWING FULL ACCESS FOR COMMISSIONING, MAINTENANCE AND REMOVAL/REPLACEMENT.
3. ALL DIMENSIONS in mm UNLESS OTHERWISE STATED.
4. DO NOT SCALE FROM THIS DRAWING.
5. FOR SYMBOLS SEE DRAWING XXXX(XX)XXXX.

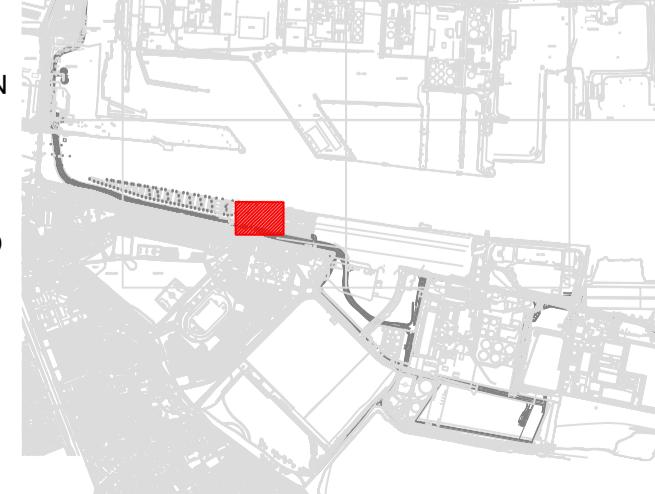

MARITIME VILLAGE LEGEND:

- CORSO 3.0
- SIMES S.P.A. GHOST RECESSED WALL LIGHT
- SPOT 4.4
- RENO HESS POLE LIGHT 180 DEGREES
- RIO UNDER BALCONY STRIP LIGHT
- ATTINA STREET LIGHT
- METRO FLOODLIGHT
- RENO 180 DEGREES HESS POLE LIGHT 360 DEGREES
- CORSO 1.0
- STRA 2.0 INGROUND UPLIGHT
- RIO 2.4D 34W RGB
- RIO INGROUND STRIP LIGHT - 1510mm
- RIO INGROUND STRIP LIGHT - 1010mm
- RIO INGROUND STRIP LIGHT - 0.510mm
- RIO INGROUND STRIP LIGHT - 0.260mm
- KASSIO BOLLARD
- METRO STREET LIGHT
- SOLO AREA LIGHT
- MEGASTAGE LED OSRAM DURIS S5
- FARO LED WIDE BEAM
- LUX LEVEL ON SURFACE

Issue Date Description By Chkd Verfd

PL01

01/07/24

LIGHTING CONCEPT

GP


DK

WD


Project
3FM PROJECT
Client
DUBIN PORT COMPANY LTD.
Drawing Status
PL01

Title
MARITIME VILLAGE CONCEPT LIGHTING DESIGN SHEET 5 OF 6
Project No.
1038937
Scale
1:200
Drawing No.
1036912-CDL-ZZ-01-DR-E-39010

CUNDALL
2 Dawson Street,
Dublin, Ireland,
D02 VK75
Tel: +353 (0)1 513 7120
Website: www.cundall.com

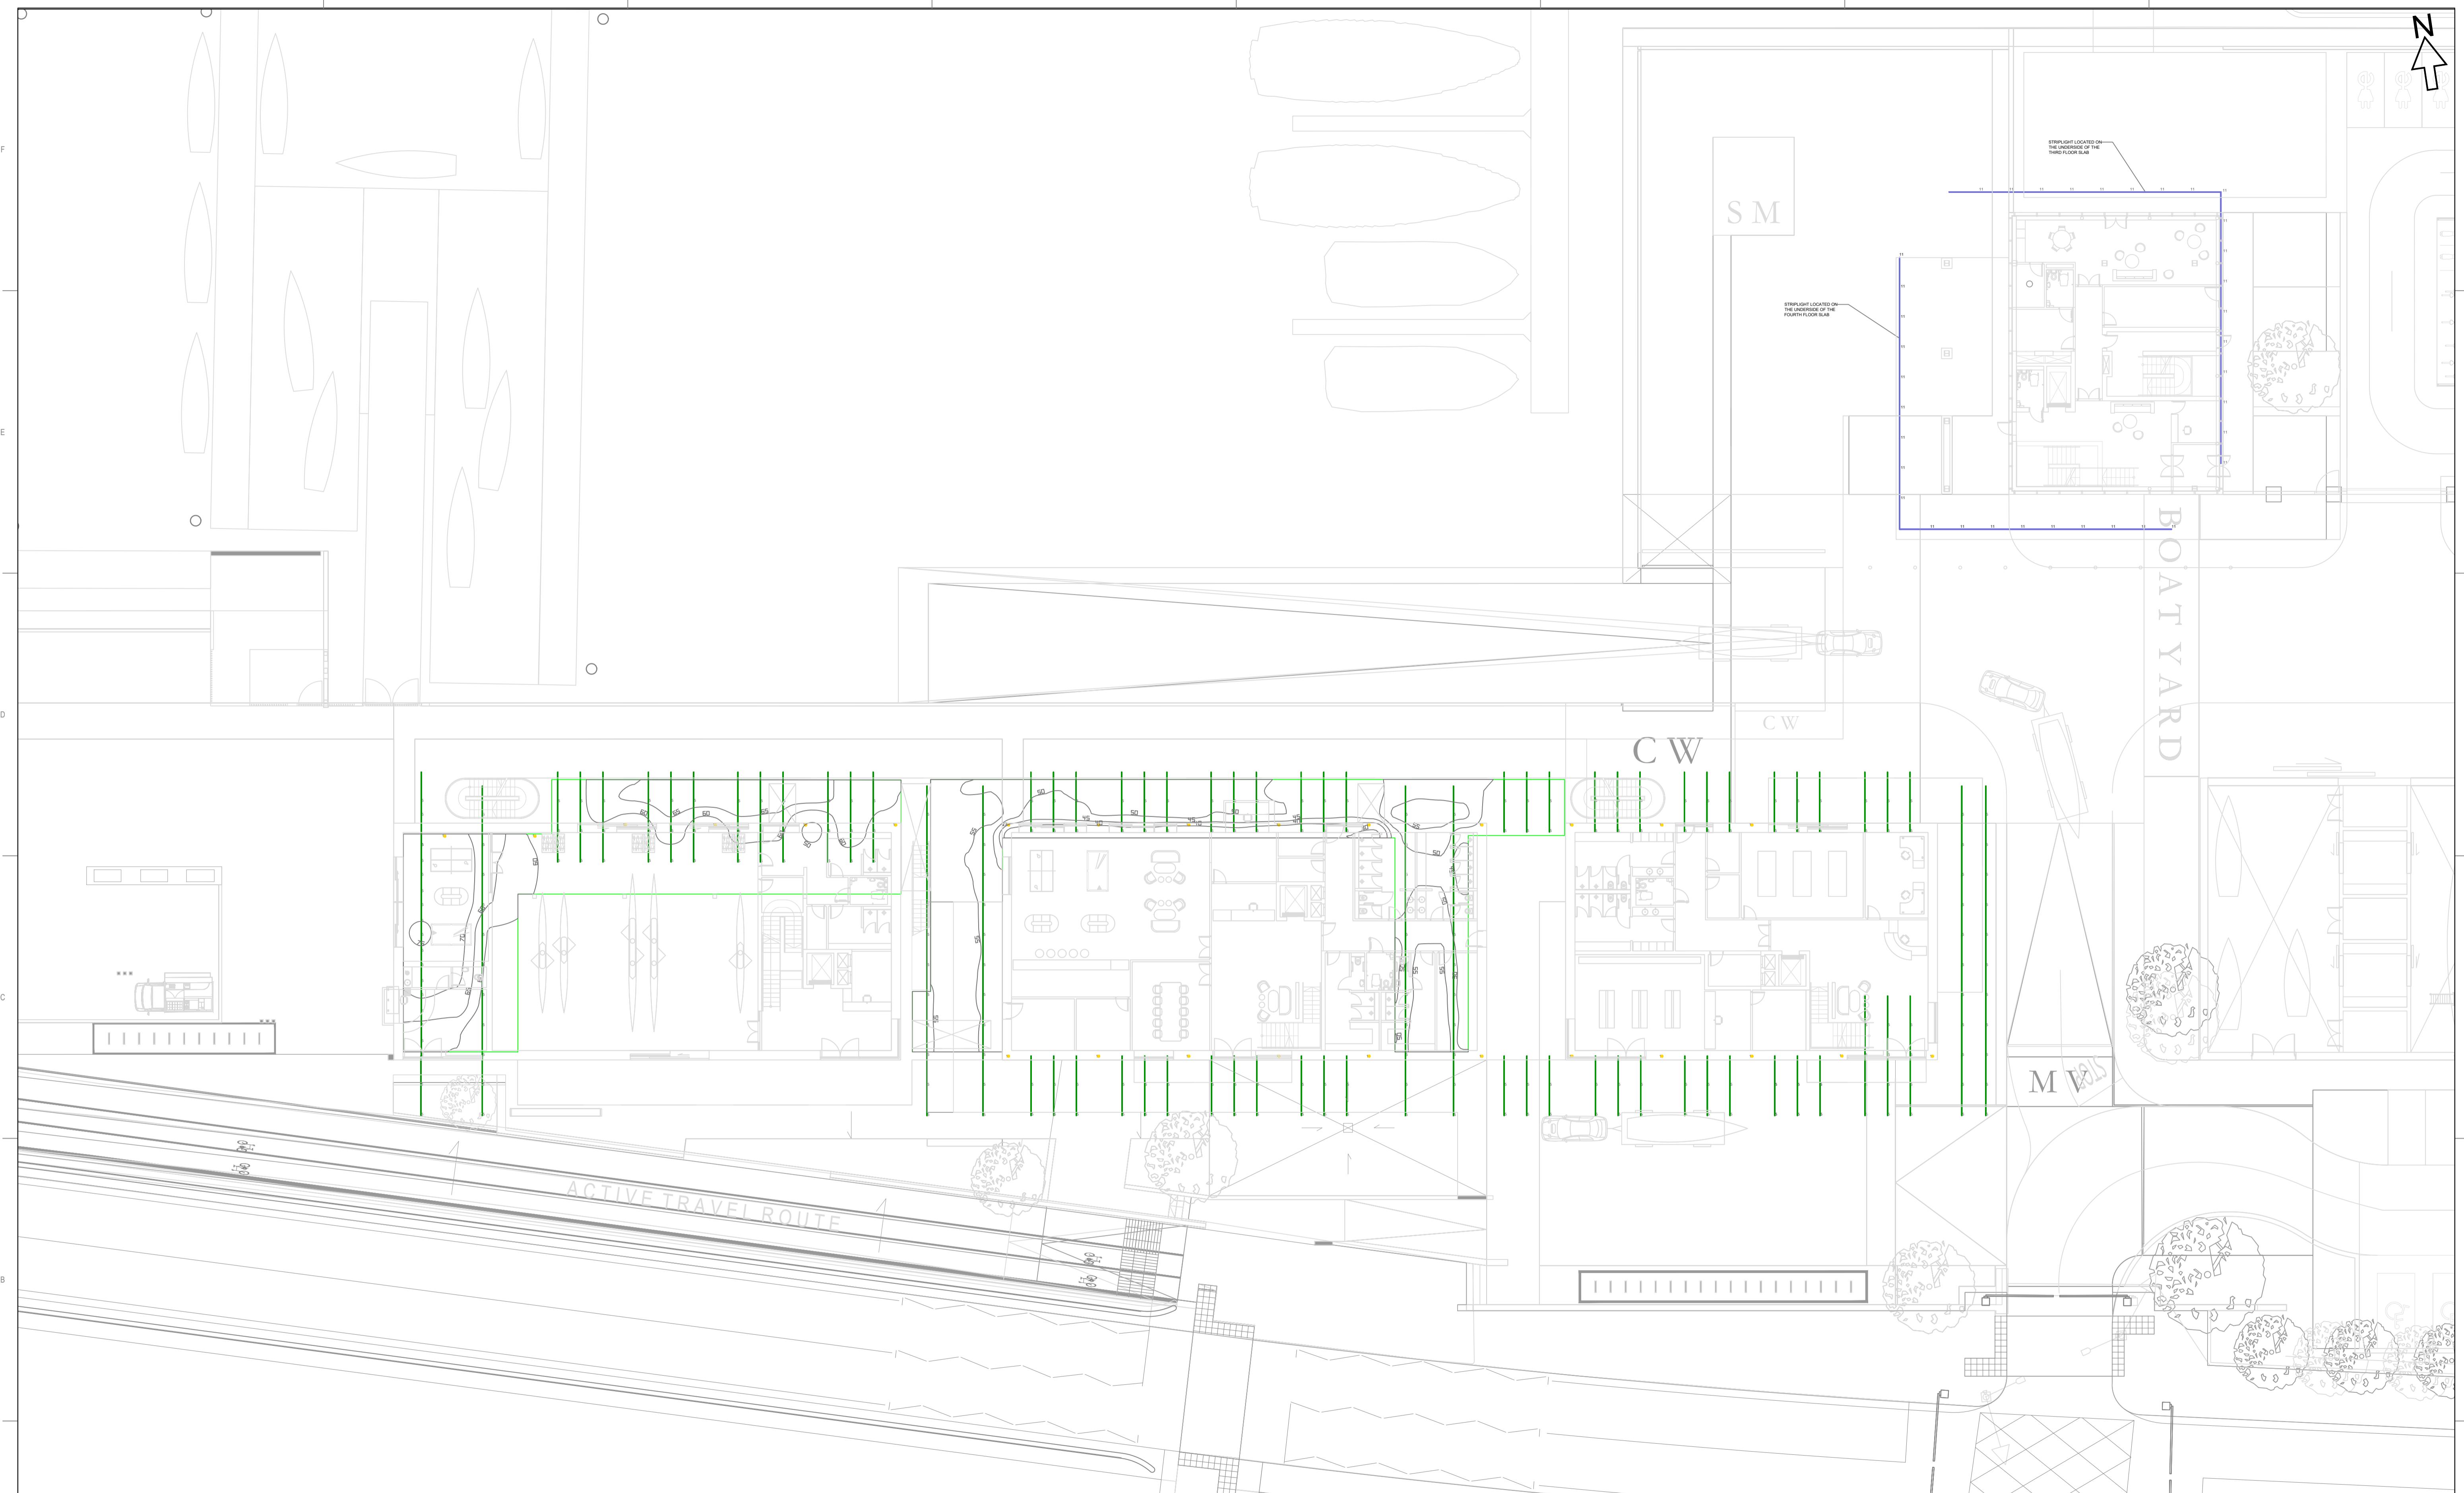

	A1
Based on: Architects Drg No. Structural Drg No. Survey Drg No. Other Drg No. Other Drg No.	Rev Rev Rev Rev Rev
THIS DRAWING MAY INDICATE ELEMENTS RELATED TO FIRE SYSTEMS. THESE ARE INDICATIVE ONLY AND FINAL NUMBER, POSITIONING AND PERFORMANCE MUST BE ESTABLISHED AS PART OF THE CDP WORKS TO MAINTAIN THE INTENT OF THE DESIGN FIRE STRATEGY	
	Notes:
	<p>1. THIS DRAWING SHALL BE READ IN CONJUNCTION WITH ALL RELEVANT ARCHITECTURAL, STRUCTURAL AND ENGINEERING SERVICES DRAWINGS, SPECIFICATIONS, SCHEDULES AND PROJECT SPECIFIC DOCUMENTS.</p> <p>2. ALL PLANT AND EQUIPMENT IS TO BE INSTALLED TO MANUFACTURER'S RECOMMENDATIONS, ALLOWING FULL ACCESS FOR COMMISSIONING, MAINTENANCE AND REMOVAL/REPLACEMENT.</p> <p>3. ALL DIMENSIONS in mm UNLESS OTHERWISE STATED.</p> <p>4. DO NOT SCALE FROM THIS DRAWING.</p> <p>5. FOR SYMBOLS SEE DRAWING XXXX(XX)XXXX.</p>

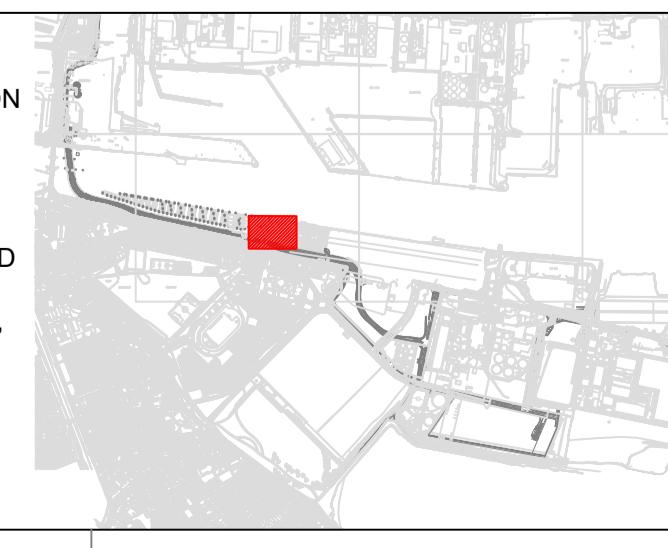

MARITIME VILLAGE LEGEND:

- CORSO 3.0
- RIO 2.4D 34W RGB
- SIMES S.P.A. GHOST RECESSED WALL LIGHT
- RIO INGROUND STRIP LIGHT - 1510mm
- △ SPOT 4.4
- RIO INGROUND STRIP LIGHT - 1010mm
- RENO HESS POLE LIGHT 180 DEGREES
- RIO INGROUND STRIP LIGHT - 510mm
- RIO UNDER BALCONY STRIP LIGHT
- KASSIO BOLLARD
- ATTINA STREET LIGHT
- METRO FLOODLIGHT
- RIO 180 DEGREES HESS POLE LIGHT 360 DEGREES
- METRO STREET LIGHT
- CORSO 1.0
- SOLO AREA LIGHT
- MEGASTAGE LED OSRAM DURIS S5
- STRA 2.0 INGROUND UPLIGHT
- FARO LED WIDE BEAM
- LUX LEVEL ON SURFACE

Project 3FM PROJECT				Title MARITIME VILLAGE CONCEPT LIGHTING DESIGN CALCULATION SURFACE SHEET 6 OF 6			
Client DUBIN PORT COMPANY LTD.							
				Project No. 1038937			
				Scale 1:200			
Drawing Status PL01				Drawing No. 1036912-CDL-ZZ-01-DR-E-39011			
Issue	Date	Description	By	Chkd	Verfd		

Cundall (Ireland) Limited
2 Dawson Street Dublin D02 VK75 Ireland
Tel:+353 (0)1 513 7120
Asia Australia Europe MENA UK and Ireland
www.cundall.com

